
EQUIPMENT SCHEDULE

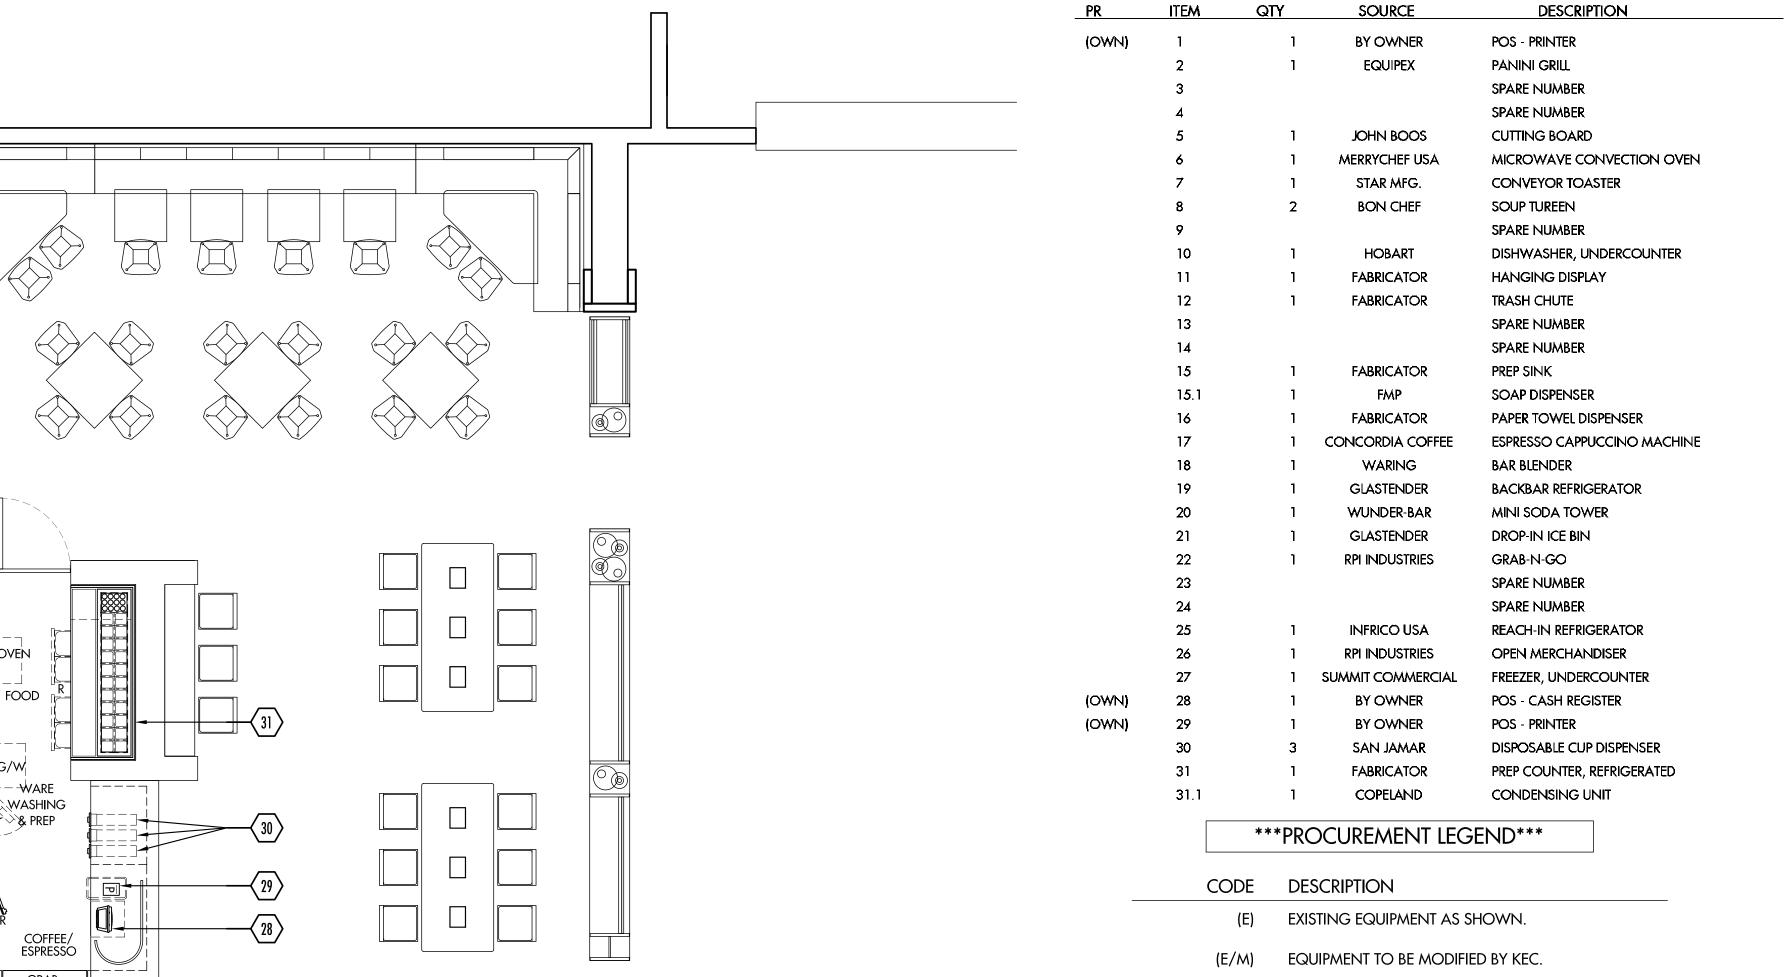

(E/M/R) EXISTING EQUIPMENT, MODIFIED BY KEC/RELOCATED. EXISTING EQUIPMENT TO BE RELOCATED. EXISTING EQUIPMENT IN STORAGE (REINSTALL). EQUIPMENT TO BE INSTALLED AT A FUTURE DATE. EQUIPMENT PROVIDED BY GENERAL CONTRACTOR. NOT IN KITCHEN EQUIPMENT CONTRACT. EQUIPMENT PROVIDED BY OTHERS. EQUIPMENT PROVIDED BY OWNER. SEPARATE SMALL WARES BID. EQUIPMENT PROVIDED BY VENDOR/SUPPLIER.

TIER 1 OPEN EQUIPMENT FLOOR PLAN (STANDARD)

REMOTE AIR COOLED COMPRESSOR.

VERIFY EXACT LOCATION

SCALE 1/4" = 1'-0"


<u>COPYRIGHT</u>©

UNAUTHORIZED USE OF THE FOODSERVICE DESIGNS, DETAILS, AutoCAD® BLOCKS, AND SPECIFICATIONS CONTAINED IN THESE DOCUMENTS IS STRICTLY PROHIBITED. NSD, INC. MAINTAINS OWNERSHIP OF SAME. THIS PROHIBITION EXTENDS FROM PRINTED MATERIAL TO ANY ELECTRONIC VERSION OF THE SAME. NO USE, OTHER THAN THAT FOR WHICH IT IS INTENDED, IS STRICTLY PROHIBITED WITHOUT WRITTEN PERMISSION FROM NEXT STEP DESIGN, INC. ALL RIGHTS RESERVED.

SUBMITTAL DATE



Market ADE

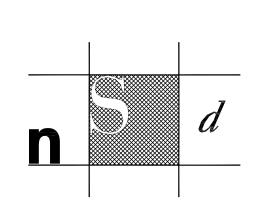

Next Step Design FOODSERVICE CONSULTANTS

913 West Street, Suite A Annapolis, MD 21401

> Ph: (410) 263-1200 Fx: (410) 280-1340 www.nextstepdesign.com

SCALE: DATE: AS NOTED

PROJECT #:

D-91*75* JRLS

FOODSERVICE OPEN EQUIPMENT FLOOR PLAN

DRAWN:

FS-T1-10S

REMOTE AIR COOLED COMPRESSOR. VERIFY EXACT LOCATION

EQUIPMENT SCHEDULE

PR	ITEM	QTY	SOURCE	DESCRIPTION
(OWN)	1	1	BY OWNER	POS - PRINTER
	2	1	EQUIPEX	PANINI GRILL
	3	1	GLASTENDER	BACKBAR REFRIGERATOR
	4	1	ROUNDUP	EGG COOKER, ELECTRIC
	5	1	JOHN BOOS	CUTTING BOARD
	6	1	MERRYCHEF USA	MICROWAVE CONVECTION OVEN
	7	1	STAR MFG.	CONVEYOR TOASTER
	8	2	BON CHEF	SOUP TUREEN
	9	1	HATCO	COUNTERTOP HEATED SHELF
	10	1	HOBART	DISHWASHER, UNDERCOUNTER
	11	1	FABRICATOR	HANGING DISPLAY
	12	1	FABRICATOR	TRASH CHUTE
	13			SPARE NUMBER
	14	7	FARRICATOR	SPARE NUMBER
	15	1	FABRICATOR	PREP SINK
	15.1	1	FMP	SOAP DISPENSER
	16 1 <i>7</i>	1	FABRICATOR CONCORDIA COFFEE	PAPER TOWEL DISPENSER ESPRESSO CAPPUCCINO MACHINE
	17	1	WARING	BAR BLENDER
	19	1	GLASTENDER	BACKBAR REFRIGERATOR
	20	1	WUNDER-BAR	MINI SODA TOWER
	20	1	GLASTENDER	DROP-IN ICE BIN
	22	1	RPI INDUSTRIES	GRAB-N-GO
	23	•	.a. a to contact	SPARE NUMBER
	24			SPARE NUMBER
	25	1	INFRICO USA	REACH-IN REFRIGERATOR
	26	1	RPI INDUSTRIES	OPEN MERCHANDISER
	27	1	SUMMIT COMMERCIAL	FREEZER, UNDERCOUNTER
WN)	28	1	BY OWNER	POS - CASH REGISTER
(NWC	29	1	BY OWNER	POS - PRINTER
	30	3	SAN JAMAR	DISPOSABLE CUP DISPENSER
	31	1	FABRICATOR	PREP COUNTER, REFRIGERATED
	31.1	1	COPELAND	CONDENSING UNIT
	32	1	FABRICATOR	TICKET RAIL
	33			SPARE NUMBER
	34			SPARE NUMBER
	35	2	SPRING USA	INDUCTION RANGE
	36	1	SPRING USA	AIR FILTER
	37	1	FABRICATOR	BUILT-IN HAND SINK W/SOAP&TOWEI
	38	1	WARING	BAR BLENDER
	39	1	FABRICATOR	BLENDER STATION
	40	2	FABRICATOR	UNDERBAR BOTTLE STEPS
END)	41	1	BY VENDOR	SODA GUN & CARBONATOR
	42	1	FABRICATOR	ICE BIN/COCKTAIL STATION
	43			SPARE NUMBER
	44	-	OI ACTEL IO CO	SPARE NUMBER
	45]	GLASTENDER	BACKBAR REFRIGERATOR
	46 47	1	AC BEVERAGE	BEER TOWER HEAD
	47		FABRICATOR	S/S ENCLOSURE
14 AV 17	48 40	 	ENOMATIC BY OMMED	REFRIGERATED WINE SYSTEM
)WN)	49 50	1	BY OWNER BY OWNER	POS - CASH REGISTER POS - PRINTER
YYINJ	50 51	1		ICE CUBER WITH BIN
	51.1	1	HOSHIZAKI EVERPURE	WATER FILTER ASSEMBLY
	3 1,1			
		P	ROCUREMENT LE	GEND
-		CODE [DESCRIPTION	
		(E) E	EXISTING EQUIPMENT AS	SHOWN.
		(E/M) E	EQUIPMENT TO BE MODI	FIED BY KEC.
	(E,	/M/R) E	EXISTING EQUIPMENT, M	ODIFIED BY KEC/RELOCATED.
		(E/R) E	EXISTING EQUIPMENT TO) BE RELOCATED.
	(E/S/R) EXISTING EQUIPMENT IN STORAGE (REINSTALL).			

EXISTING EQUIPMENT IN STORAGE (REINSTALL). EQUIPMENT TO BE INSTALLED AT A FUTURE DATE. EQUIPMENT PROVIDED BY GENERAL CONTRACTOR. NOT IN KITCHEN EQUIPMENT CONTRACT. EQUIPMENT PROVIDED BY OTHERS. EQUIPMENT PROVIDED BY OWNER.

SEPARATE SMALL WARES BID.

EQUIPMENT PROVIDED BY VENDOR/SUPPLIER.

TIER 1 OPEN EQUIPMENT FLOOR PLAN (W/ ADDITIONAL OPTIONS)


SCALE 1/4" = 1'-0"

<u>COPYRIGHT</u>[©]

UNAUTHORIZED USE OF THE FOODSERVICE DESIGNS, DETAILS, AutoCAD® BLOCKS, AND SPECIFICATIONS CONTAINED IN THESE MATERIAL TO ANY ELECTRONIC VERSION OF THE SAME. NO USE, OTHER THAN THAT FOR WHICH IT IS INTENDED, IS STRICTLY PROHIBITED WITHOUT WRITTEN PERMISSION FROM NEXT STEP DESIGN, INC. ALL RIGHTS RESERVED.

SUBMITTAL	DATE
~	
~	
~	
~	
~	
~	



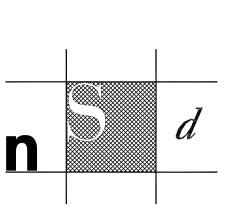

Next Step Design FOODSERVICE CONSULTANTS

913 West Street, Suite A Annapolis, MD 21401


Ph: (410) 263-1200 Fx: (410) 280-1340 www.nextstepdesign.com

DATE: SCALE: AS NOTED

PROJECT #: DRAWN: D-91*75* JRLS

FOODSERVICE OPEN EQUIPMENT FLOOR PLAN

FS-T1-10P

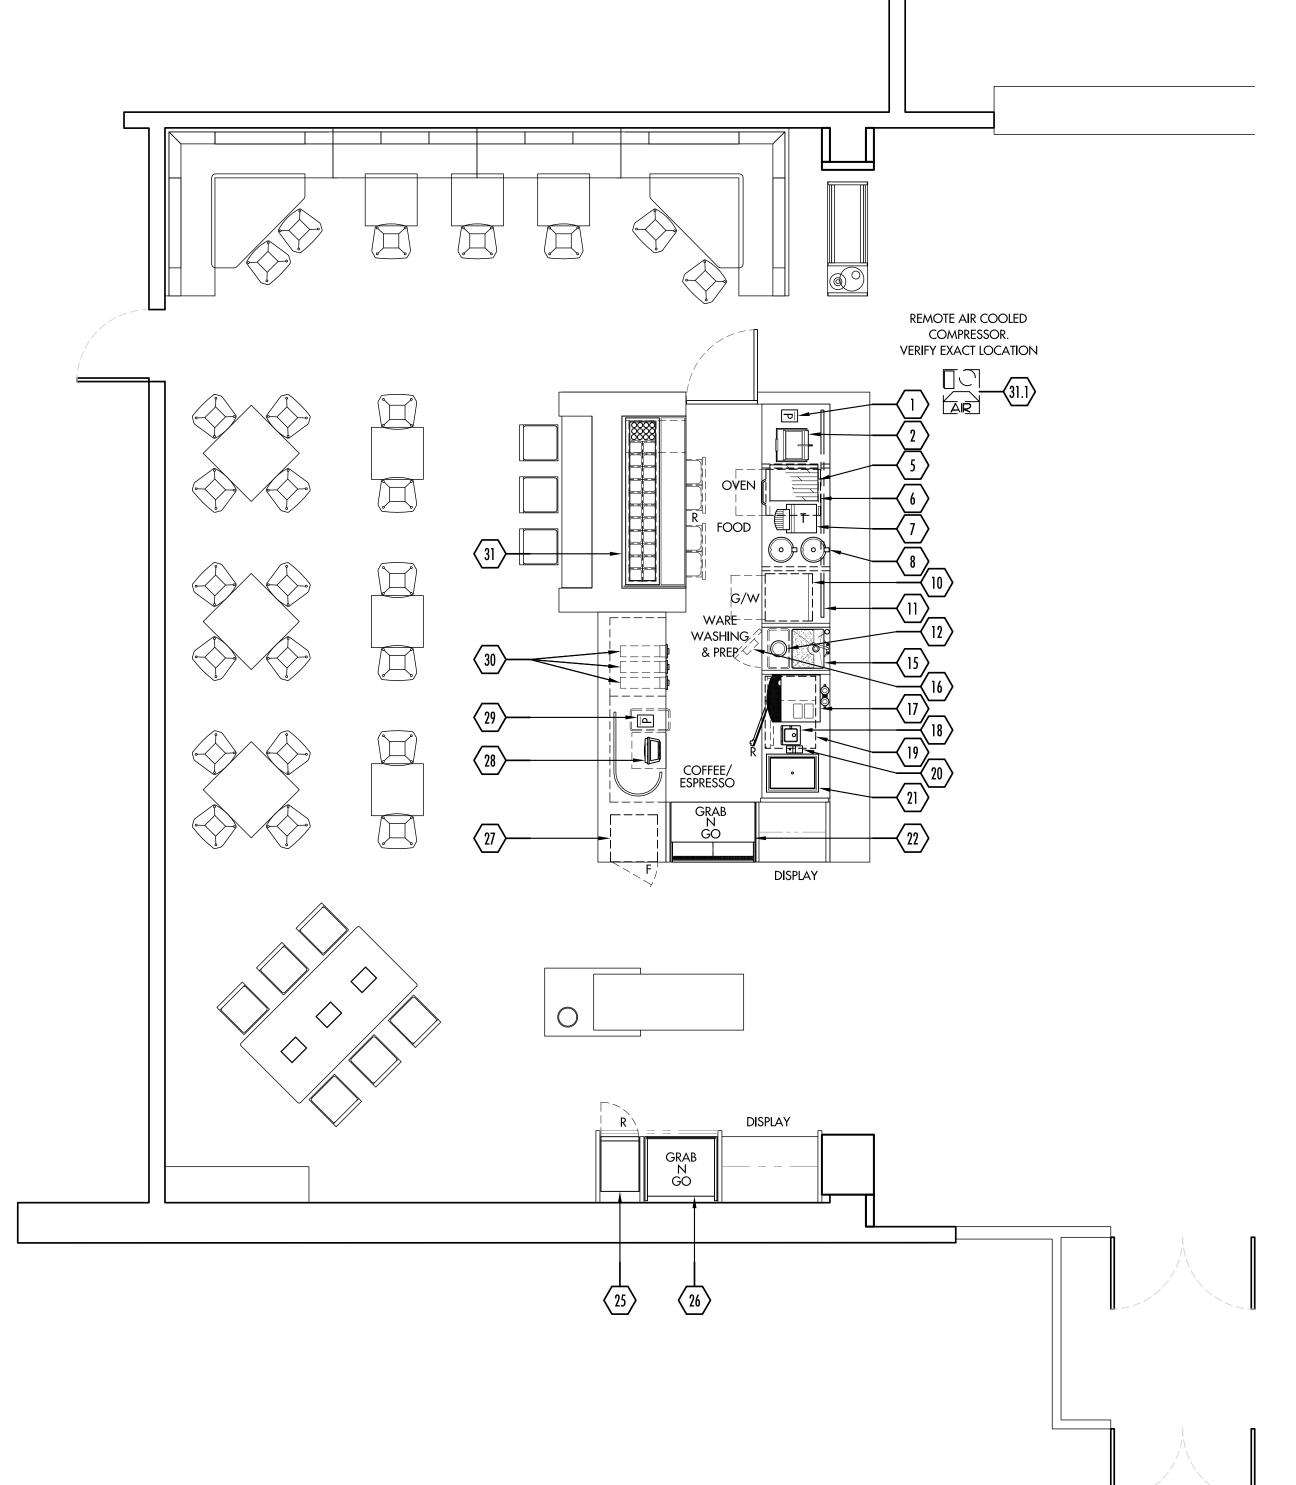

EQUIPMENT SCHEDULE

PR	ITEM	QTY	SOURCE	DESCRIPTION
(OWN)	1	1	BY OWNER	POS - PRINTER
	2	1	EQUIPEX	PANINI GRILL
	3			SPARE NUMBER
	4			SPARE NUMBER
	5	1	JOHN BOOS	CUTTING BOARD
	6	1	MERRYCHEF USA	MICROWAVE CONVECTION OVEN
	7	1	STAR MFG.	CONVEYOR TOASTER
	8	2	BON CHEF	SOUP TUREEN
	9			SPARE NUMBER
	10	1	HOBART	DISHWASHER, UNDERCOUNTER
	11	1	FABRICATOR	HANGING DISPLAY
	12	1	FABRICATOR	TRASH CHUTE
	13			SPARE NUMBER
	14			SPARE NUMBER
	15	1	FABRICATOR	PREP SINK
	15.1	1	FMP	SOAP DISPENSER
	16	1	FABRICATOR	PAPER TOWEL DISPENSER
	1 <i>7</i>	1	CONCORDIA COFFEE	ESPRESSO CAPPUCCINO MACHINE
	18	1	WARING	BAR BLENDER
	19	1	GLASTENDER	BACKBAR REFRIGERATOR
	20	1	WUNDER-BAR	MINI SODA TOWER
	21	1	GLASTENDER	DROP-IN ICE BIN
	22	1	RPI INDUSTRIES	GRAB-N-GO
	23			SPARE NUMBER
	24			SPARE NUMBER
	25	1	INFRICO USA	REACH-IN REFRIGERATOR
	26	1	RPI INDUSTRIES	OPEN MERCHANDISER
	27	1	SUMMIT COMMERCIAL	FREEZER, UNDERCOUNTER
(OWN)	28	1	BY OWNER	POS - CASH REGISTER
(OWN)	29	1	BY OWNER	POS - PRINTER
	30	3	SAN JAMAR	DISPOSABLE CUP DISPENSER
	31	1	FABRICATOR	PREP COUNTER, REFRIGERATED
	31.1	1	COPELAND	CONDENSING UNIT

PROCUREMENT LEGEND

CODE	DESCRIPTION
(E)	EXISTING EQUIPMENT AS SHOWN.
(E/M)	EQUIPMENT TO BE MODIFIED BY KEC.
(E/M/R)	EXISTING EQUIPMENT, MODIFIED BY KEC/RELOCATED.
(E/R)	EXISTING EQUIPMENT TO BE RELOCATED.
(E/S/R)	EXISTING EQUIPMENT IN STORAGE (REINSTALL).
(FUT)	EQUIPMENT TO BE INSTALLED AT A FUTURE DATE.
(GC)	EQUIPMENT PROVIDED BY GENERAL CONTRACTOR.
(NIKEC)	NOT IN KITCHEN EQUIPMENT CONTRACT.
(OTHER)	EQUIPMENT PROVIDED BY OTHERS.
(OWN)	EQUIPMENT PROVIDED BY OWNER.
(SMWRS)	SEPARATE SMALL WARES BID.
(VEND)	EQUIPMENT PROVIDED BY VENDOR/SUPPLIER.


UNAUTHORIZED USE OF THE FOODSERVICE DESIGNS, DETAILS, AutoCAD® BLOCKS, AND SPECIFICATIONS CONTAINED IN THESE DOCUMENTS IS STRICTLY PROHIBITED. NSD, INC. MAINTAINS OWNERSHIP OF SAME. THIS PROHIBITION EXTENDS FROM PRINTED MATERIAL TO ANY ELECTRONIC VERSION OF THE SAME. NO USE, OTHER THAN THAT FOR WHICH IT IS INTENDED, IS STRICTLY

PROHIBITED WITHOUT WRITTEN PERMISSION FROM NEXT STEP DESIGN, INC. ALL RIGHTS RESERVED.

<u>COPYRIGHT</u>©

SUBMITTAL



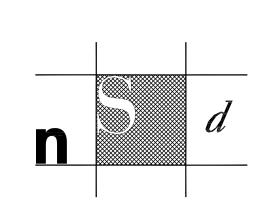

Next Step Design FOODSERVICE CONSULTANTS

913 West Street, Suite A Annapolis, MD 21401

> Ph: (410) 263-1200 Fx: (410) 280-1340 www.nextstepdesign.com

DATE: SCALE: AS NOTED PROJECT #: DRAWN:


D-91*75* JRLS

FOODSERVICE FILTERED EQUIPMENT FLOOR PLAN

FS-T1-1FS

TIER 1 FILTERED EQUIPMENT FLOOR PLAN (STANDARD)

SCALE 1/4" = 1'-0"

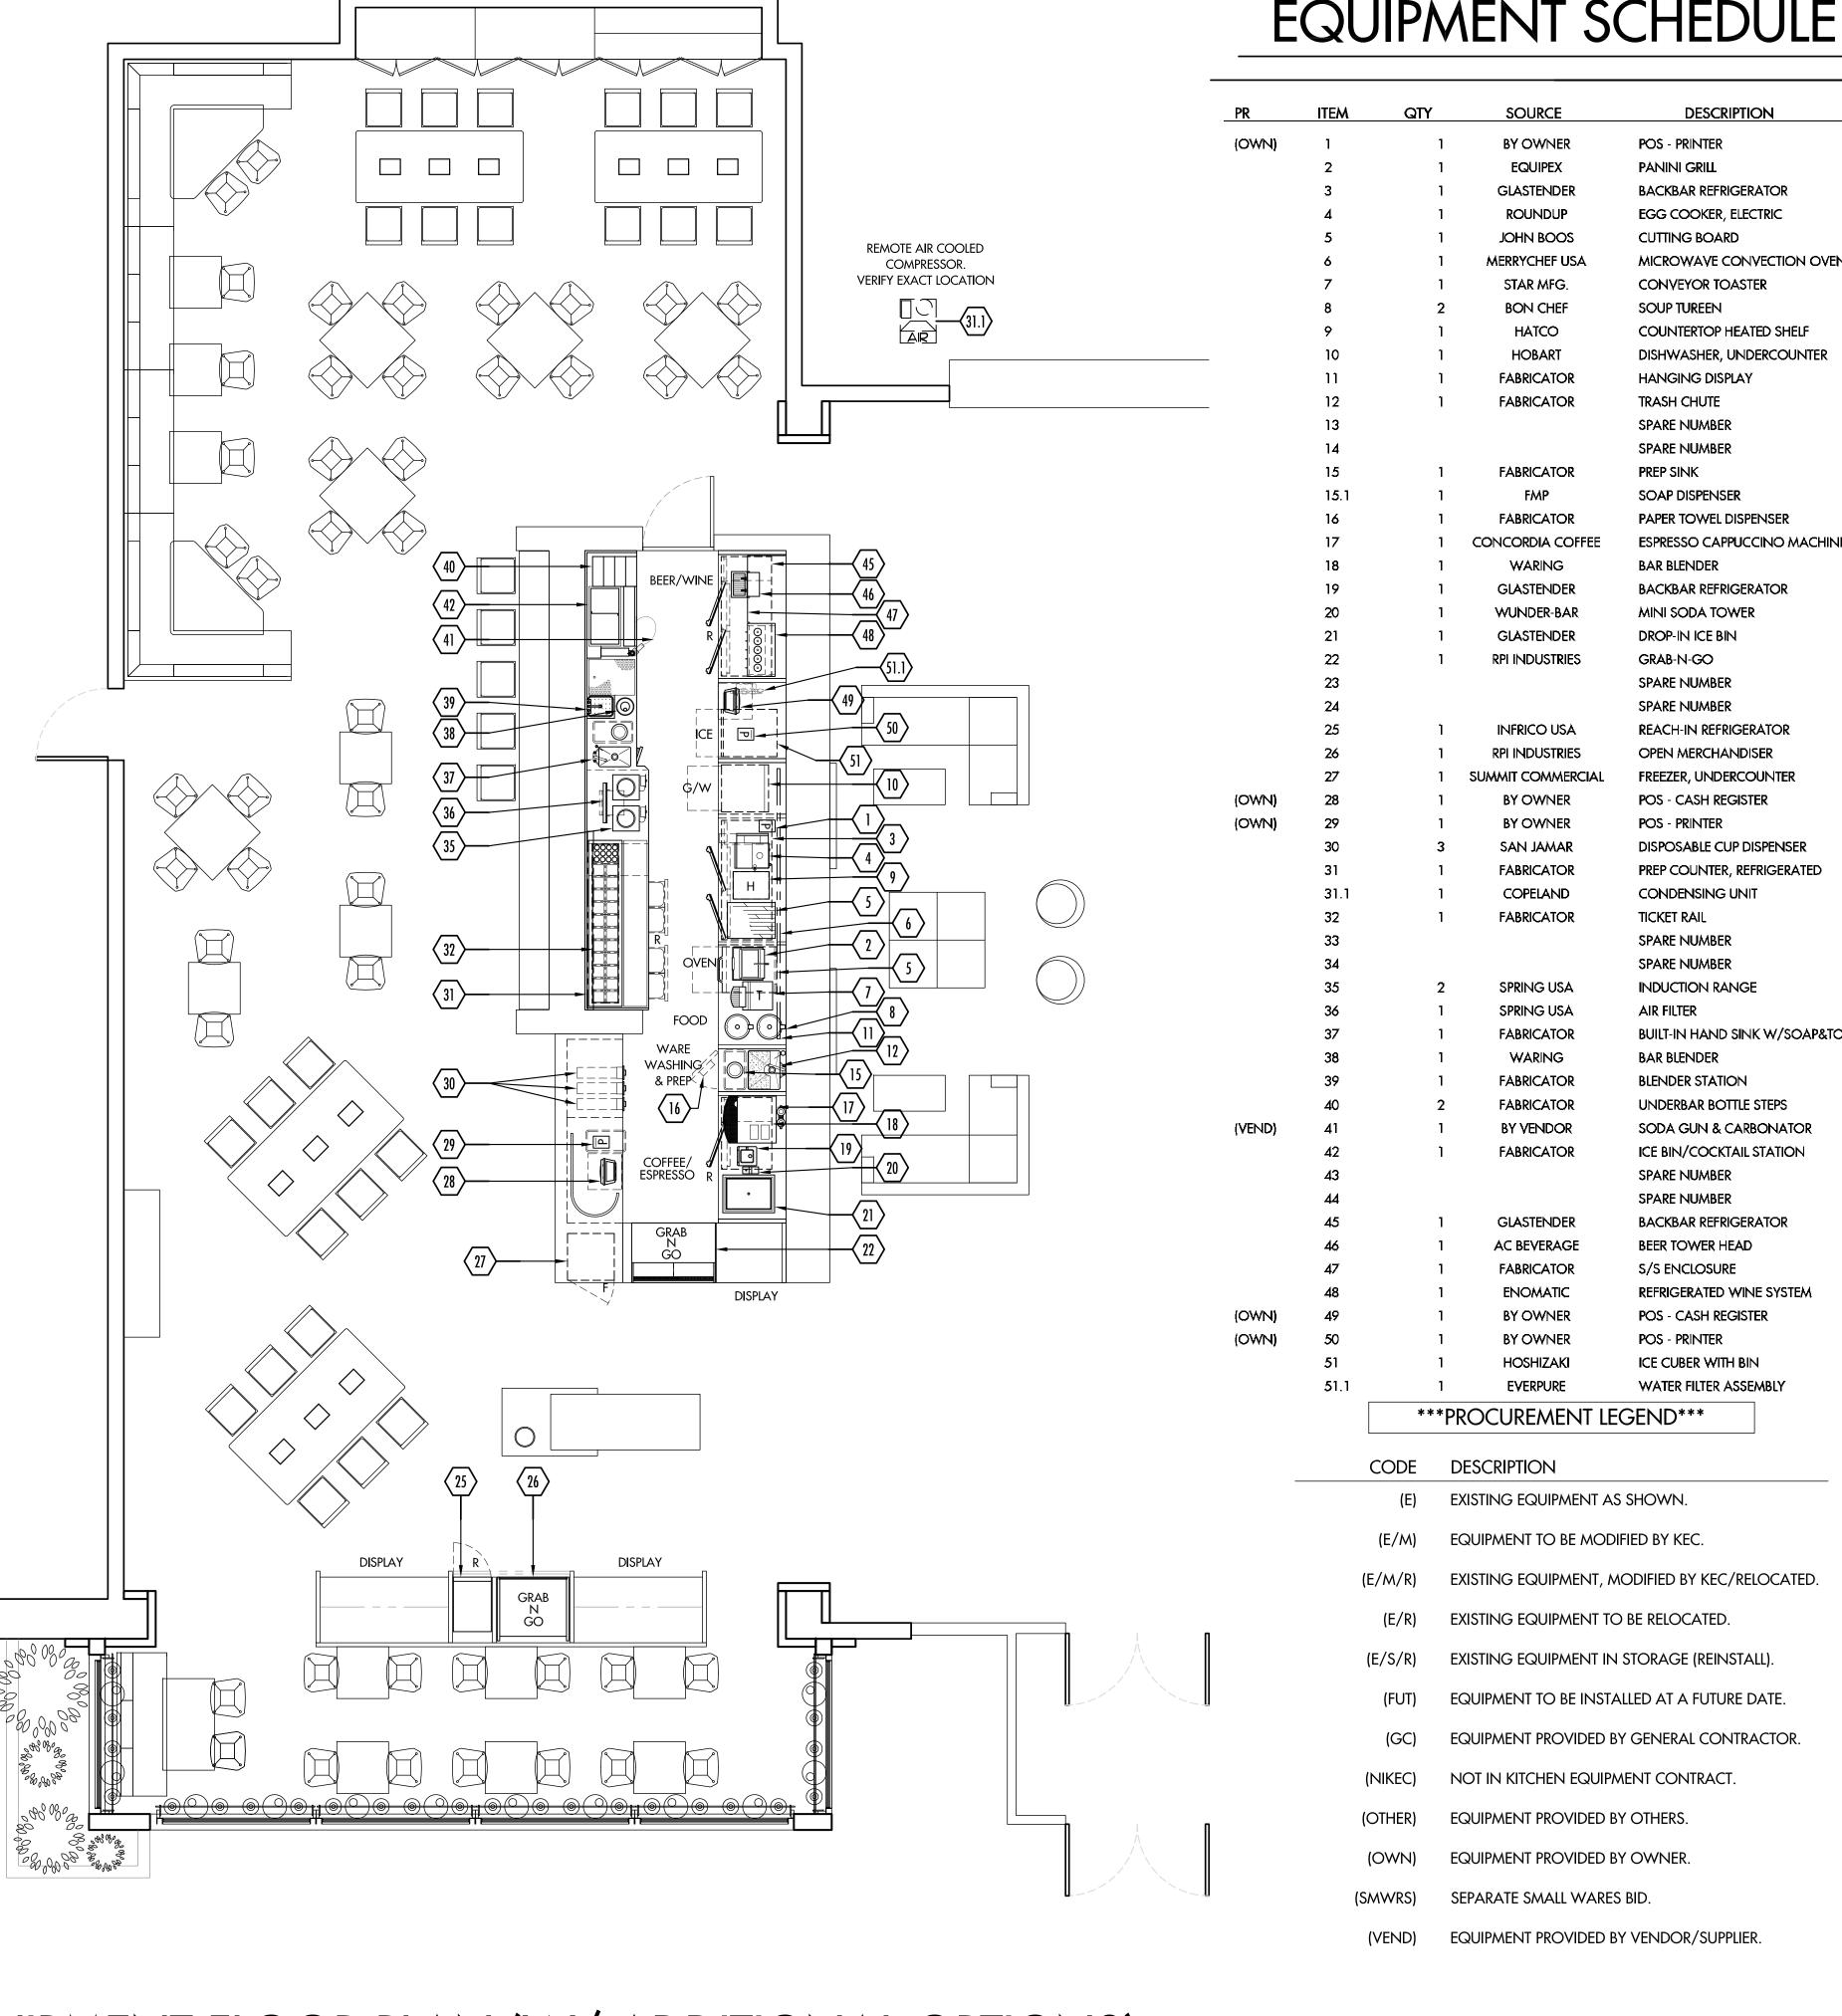

EQUIPMENT SCHEDULE

MICROWAYE CONVECTION OVEN ESPRESSO CAPPUCCINO MACHINE BUILT-IN HAND SINK W/SOAP&TOWEL

TIER 1 FILTERED EQUIPMENT FLOOR PLAN (W/ ADDITIONAL OPTIONS)


SCALE 1/4" = 1'-0"

<u>COPYRIGHT</u>[©]

UNAUTHORIZED USE OF THE FOODSERVICE DESIGNS, DETAILS, AUTOCAD® BLOCKS, AND SPECIFICATIONS CONTAINED IN THESE DOCUMENTS IS STRICTLY PROHIBITED. NSD, INC. MAINTAINS OWNERSHIP OF SAME. THIS PROHIBITION EXTENDS FROM PRINTED MATERIAL TO ANY ELECTRONIC VERSION OF THE SAME. NO USE, OTHER THAN THAT FOR WHICH IT IS INTENDED, IS STRICTLY PROHIBITED WITHOUT WRITTEN PERMISSION FROM NEXT STEP DESIGN,INC. ALL RIGHTS RESERVED.

SUBMITTAL DATE



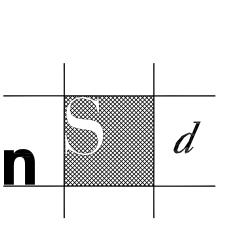

Next Step Design FOODSERVICE CONSULTANTS

913 West Street, Suite A Annapolis, MD 21401


Ph: (410) 263-1200 Fx: (410) 280-1340 www.nextstepdesign.com


DATE: SCALE: AS NOTED

PROJECT #: DRAWN: D-9175 JRLS

FOODSERVICE FILTERED EQUIPMENT FLOOR PLAN

FS-T1-1FOP

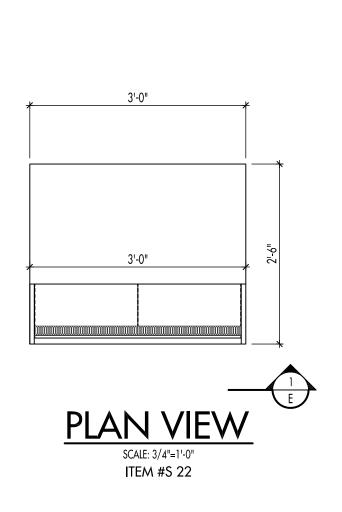

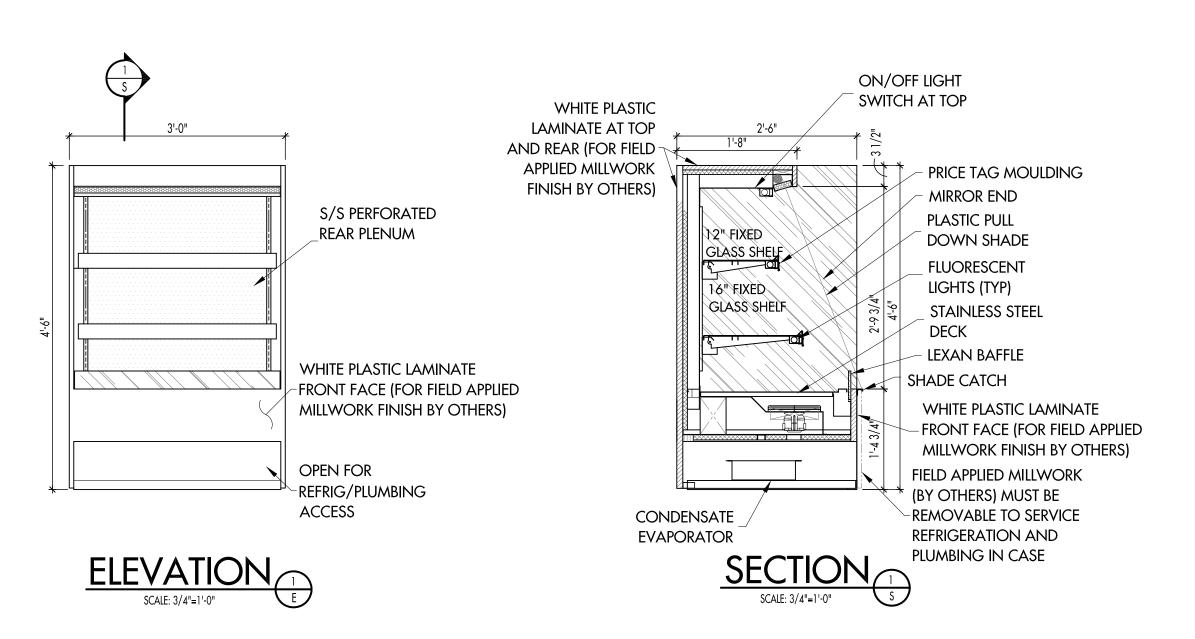

- 1. ALL EXPOSED EXTERIOR SURFACES (UNLESS NOTED OTHERWISE): STANDARD PLASTIC LAMINATE - WHITE MATTE, VERIFY WITH MILLWORK CONTRACTOR
- 2. PULL DOPWN PLASTIC ENERGY SHADE WITH LOCK FOR ITEM 20, LEXAN SECURITY PANELS FOR ITEM 21.
- 3. UPPER REAR SLIDING DOORS O.W.M. REAR LOADING DOOR WITH LOCK

REFRIGERATION (BOTH CASES):

- REMOTE W/ TXV (R-404A) - REMOTE REFRIGERATION TEMPERATURE CONTROL PACKAGE W/DIGITAL THERMOMETER

- (1) COMPRESSOR INSTALLED BY OTHERS AT NO MORE THAN 100' PIPE RUN

ELECTRICAL (PER CASE): 120V/1PH/60HZ, 3 AMPS. 'J' BOX AT BASE

ELECTRICAL (REMOTE COMPRESSOR): 208V-230V/1PH/60HZ, 15 AMPS.

COMPRESSOR DIMENSIONS: - 28 1/2"D X 37 3/4"W X 17 1/2"H - 193 LBS





PROJECT #: DRAWN: D-9175 DB/REFCON

DATE:

SUBMITTAL

Market

MADE

DATE

FOODSERVICE CUSTOM DISPLAY CASE DETAILS

Next Step Design FOODSERVICE CONSULTANTS

913 West Street, Suite A Annapolis, MD 21401

> Ph: (410) 263-1200 Fx: (410) 280-1340 www.nextstepdesign.com

> > SCALE:

3/4"=1'-0"


FS-T1-CC1

CUSTOM DISPLAY CASE DETAILS


————— SCALE AS NOTED —————

<u>COPYRIGHT</u>[©]

UNAUTHORIZED USE OF THE FOODSERVICE DESIGNS, DETAILS, AutoCAD® BLOCKS, AND SPECIFICATIONS CONTAINED IN THESE DOCUMENTS IS STRICTLY PROHIBITED. NSD, INC. MAINTAINS OWNERSHIP OF SAME. THIS PROHIBITION EXTENDS FROM PRINTED MATERIAL TO ANY ELECTRONIC VERSION OF THE SAME. NO USE, OTHER THAN THAT FOR WHICH IT IS INTENDED, IS STRICTLY PROHIBITED WITHOUT WRITTEN PERMISSION FROM NEXT STEP DESIGN, INC. ALL RIGHTS RESERVED.

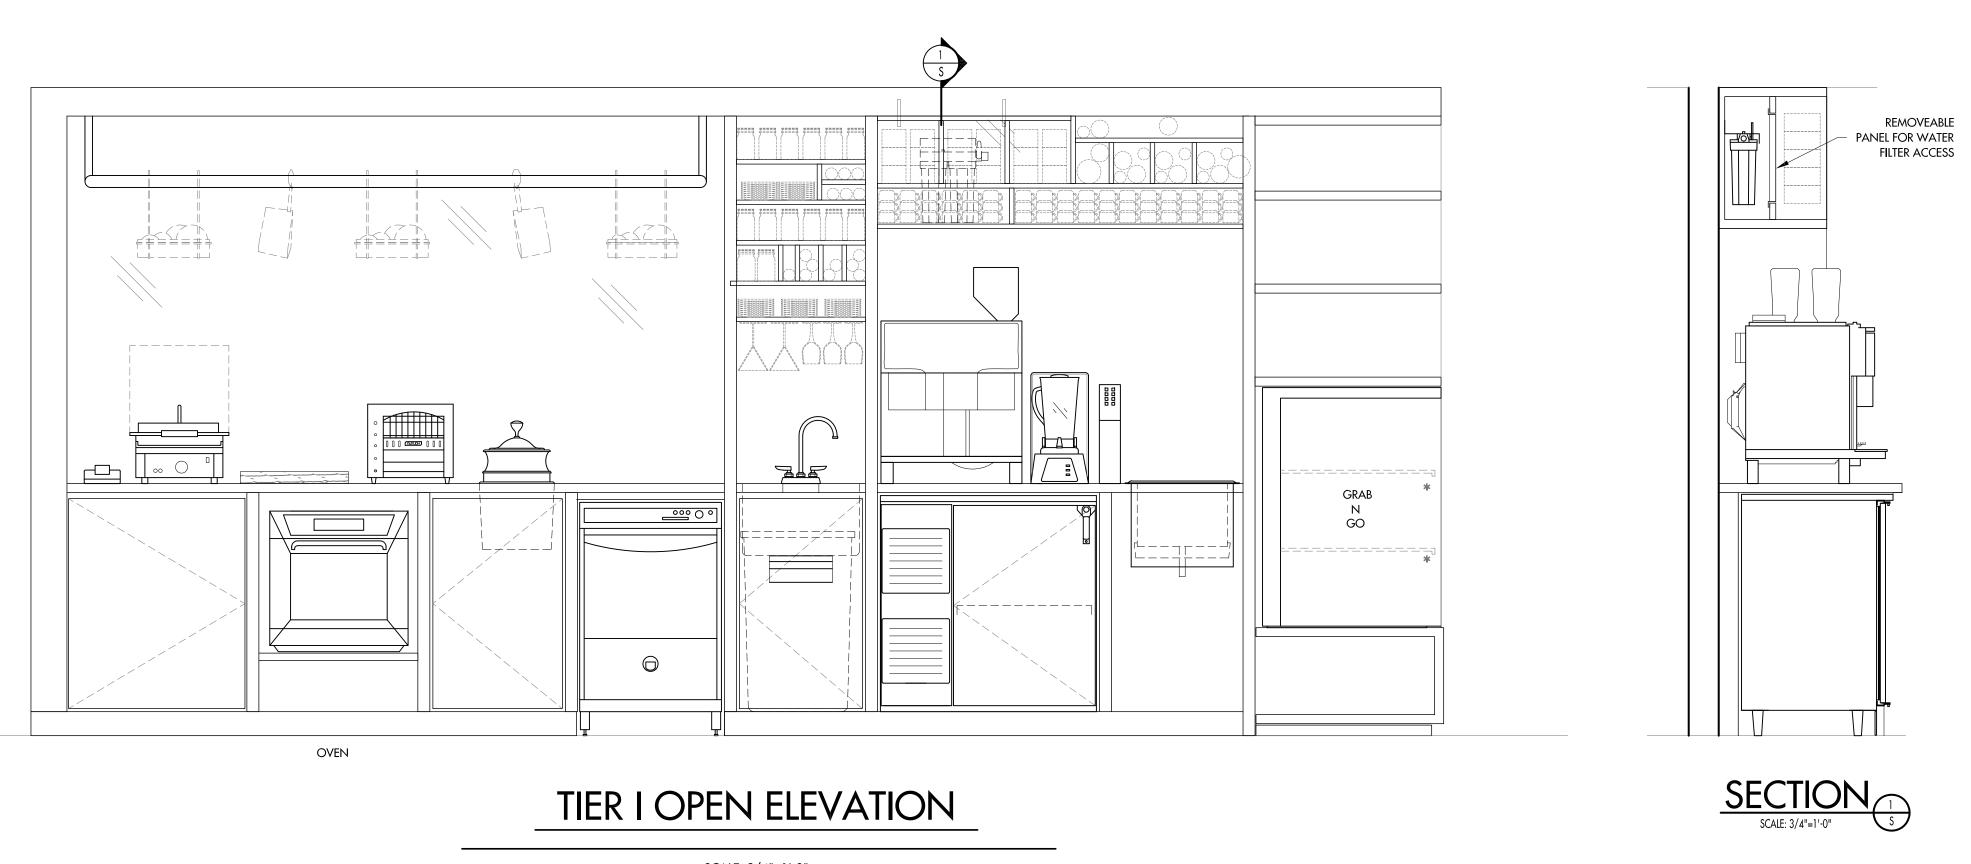

SCALE: 3/4"=1'-0" REFER TO SHEET FS-T1-1OS FOR FURTHER DETAILS.

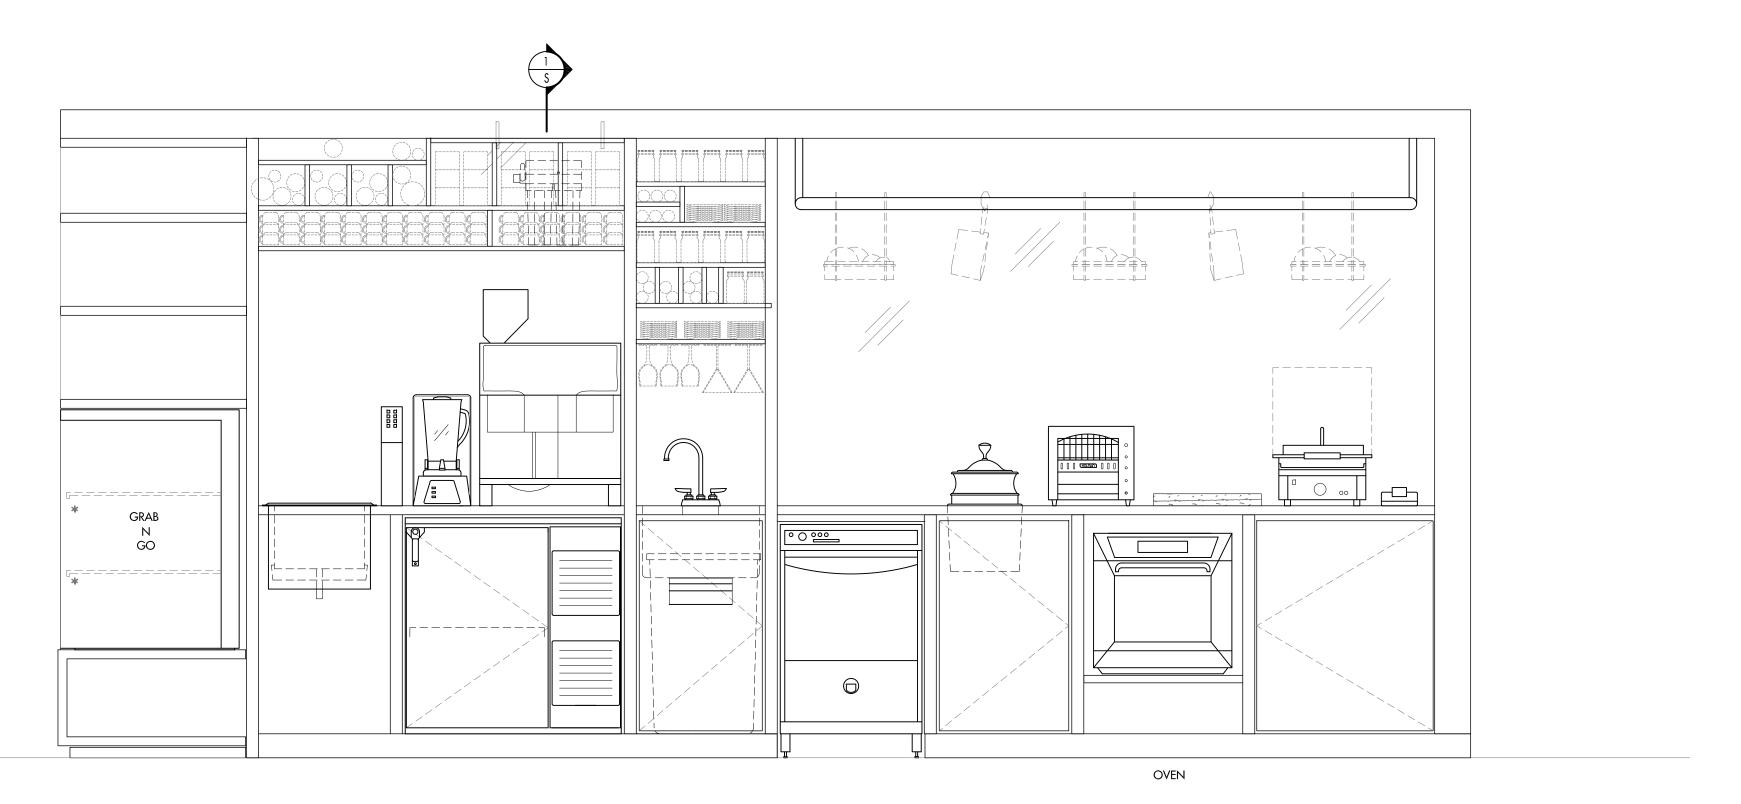

TIER I OPEN ELEVATION

SCALE: 3/4"=1'-0" REFER TO SHEET FS-T1-1OP FOR FURTHER DETAILS.

FABRICATION ELEVATIONS


------ SCALE AS NOTED ------

<u>COPYRIGHT</u>[©]

UNAUTHORIZED USE OF THE FOODSERVICE DESIGNS, DETAILS, AutoCAD® BLOCKS, AND SPECIFICATIONS CONTAINED IN THESE DOCUMENTS IS STRICTLY PROHIBITED. NSD, INC. MAINTAINS OWNERSHIP OF SAME. THIS PROHIBITION EXTENDS FROM PRINTED MATERIAL TO ANY ELECTRONIC VERSION OF THE SAME. NO USE, OTHER THAN THAT FOR WHICH IT IS INTENDED, IS STRICTLY PROHIBITED WITHOUT WRITTEN PERMISSION FROM NEXT STEP DESIGN, INC. ALL RIGHTS RESERVED.

SUBMITTAL DATE



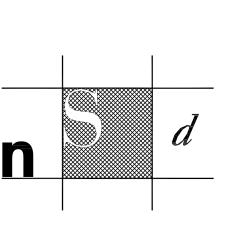

Next Step Design FOODSERVICE CONSULTANTS


913 West Street, Suite A Annapolis, MD 21401

Ph: (410) 263-1200 Fx: (410) 280-1340 www.nextstepdesign.com

AS NOTED PROJECT #: DRAWN: D-91*75* JRLS


FOODSERVICE FABRICATION ELEVATIONS

FS-T1-EL1

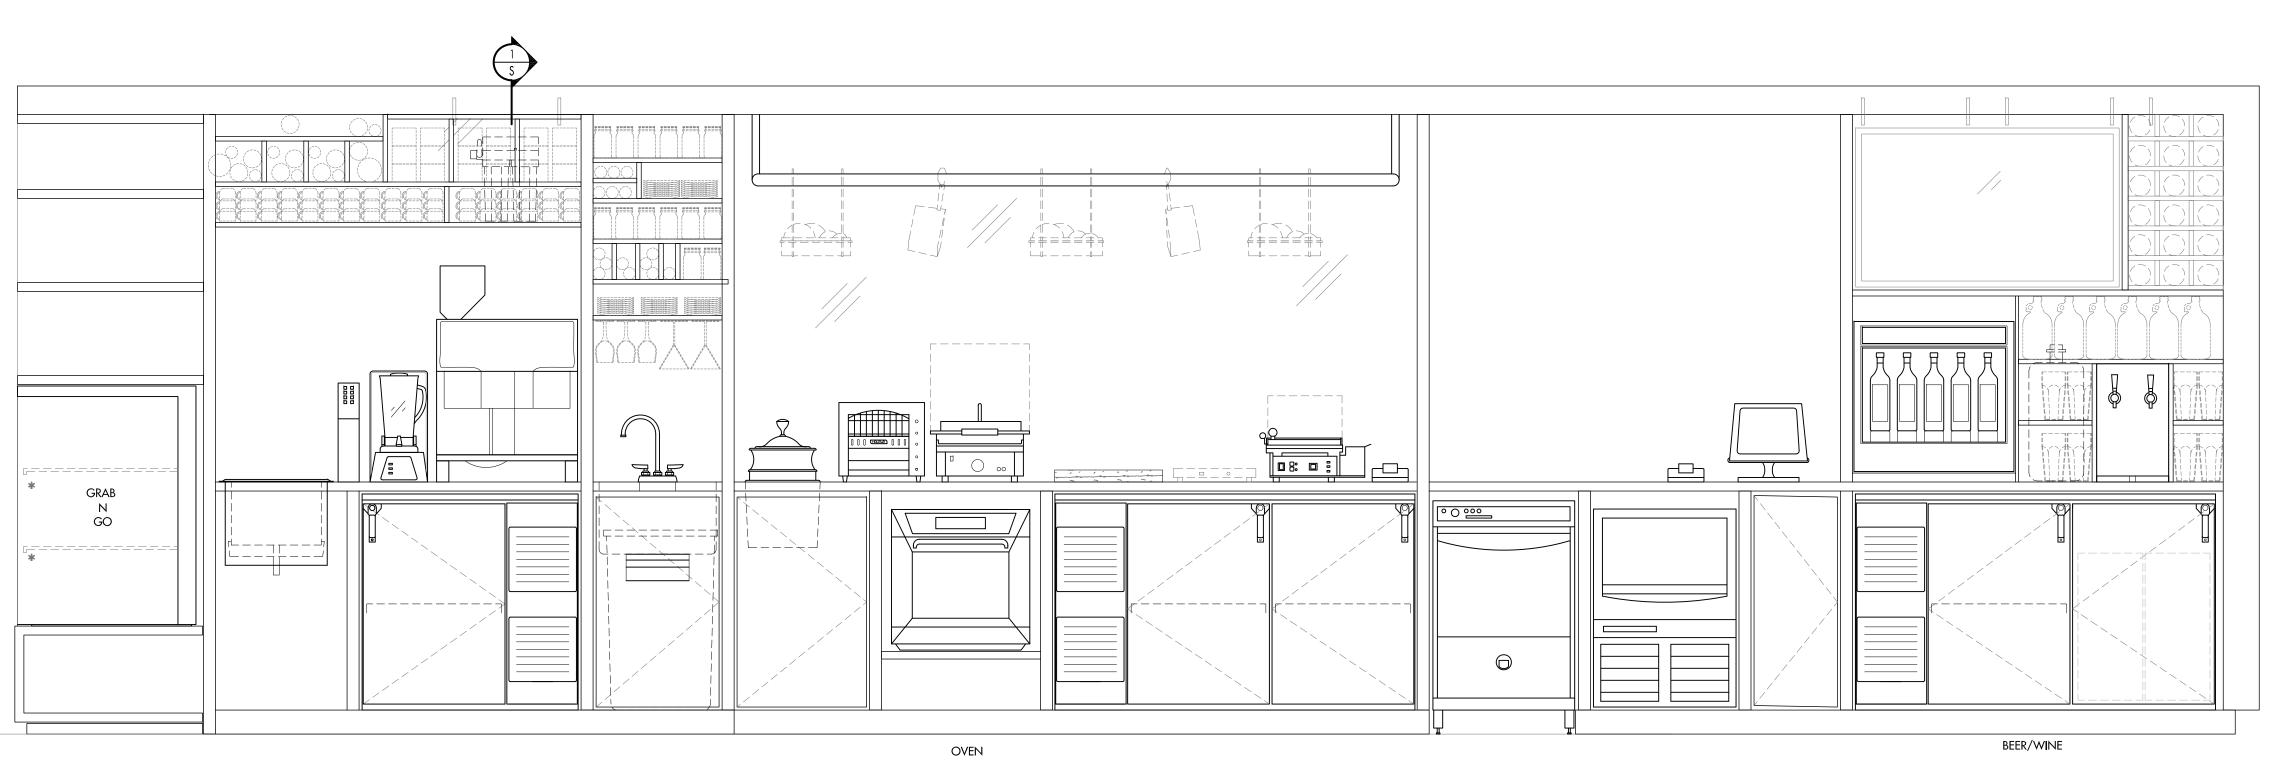

TIER I OPEN /W ADDITIONAL OPTIONS ELEVATION

REFER TO SHEET FS-T1-1FS FOR FURTHER DETAILS.

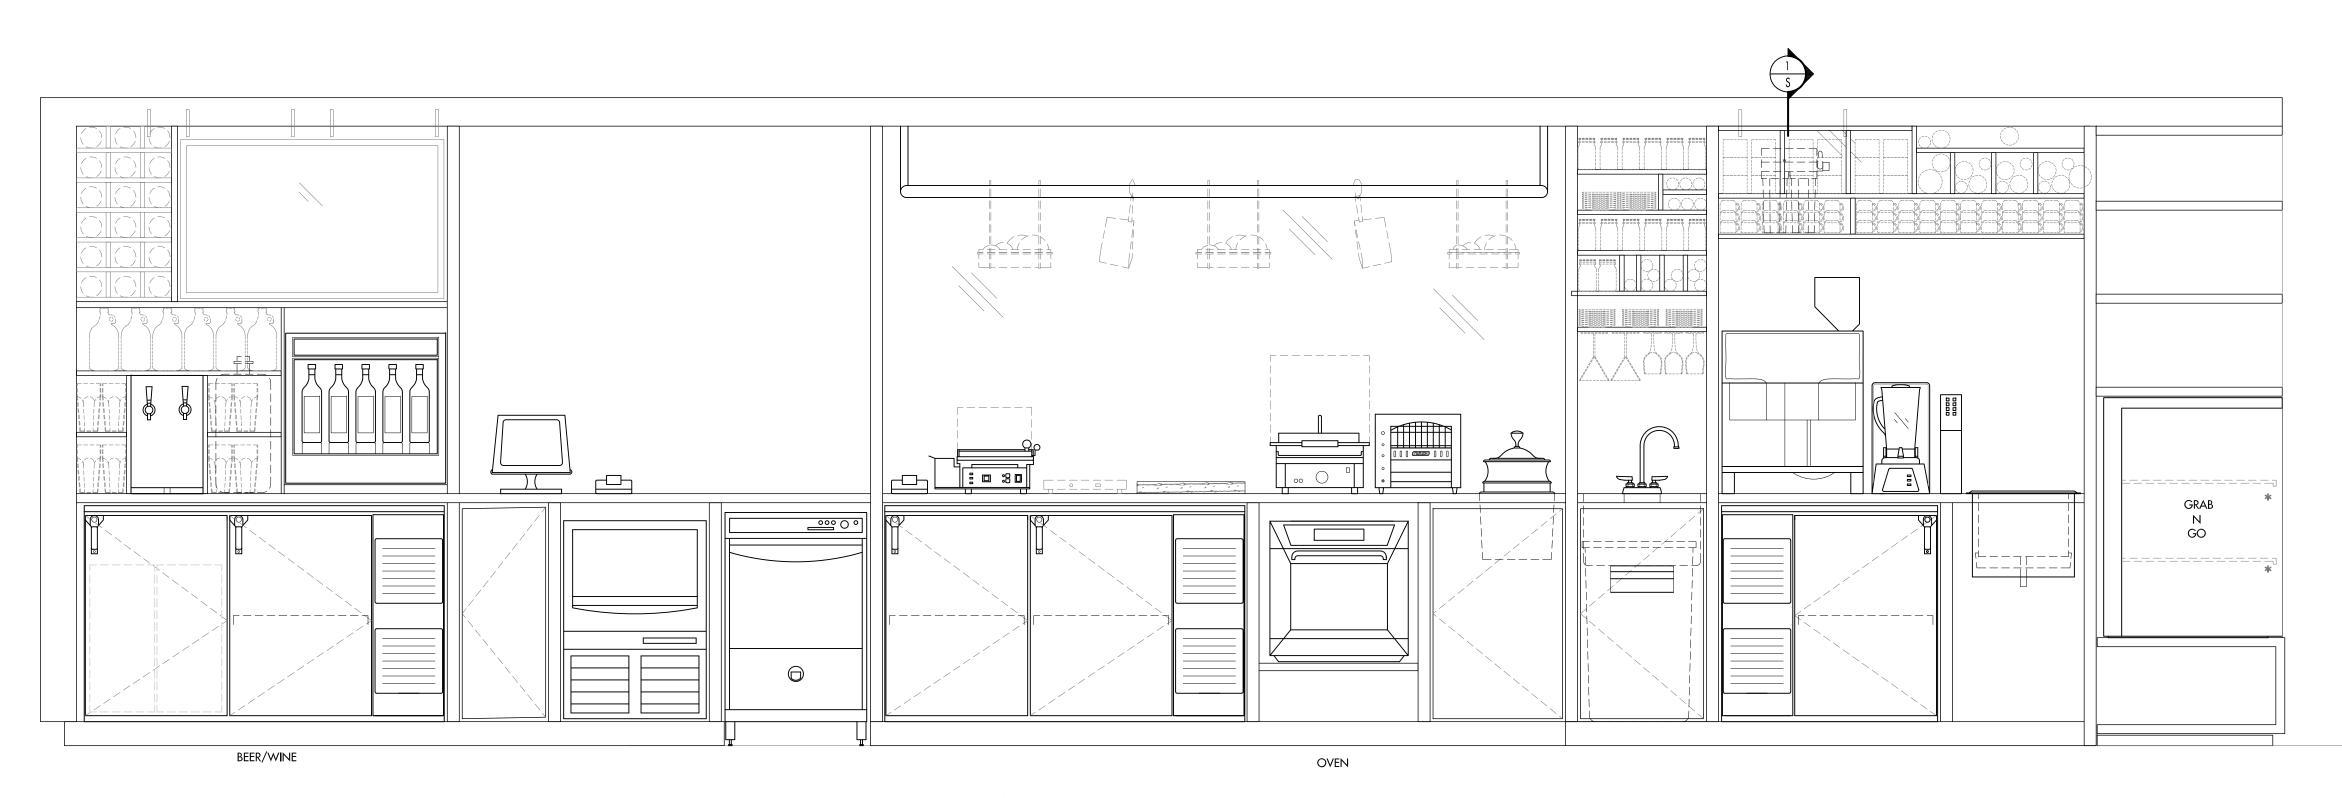

TIER I OPEN /W ADDITIONAL OPTIONS ELEVATION

REFER TO SHEET FS-T1-1FOP FOR FURTHER DETAILS.

FABRICATION ELEVATIONS

SCALE AS NOTED



<u>COPYRIGHT</u>©

UNAUTHORIZED USE OF THE FOODSERVICE DESIGNS, DETAILS, AutoCAD® BLOCKS, AND SPECIFICATIONS CONTAINED IN THESE DOCUMENTS IS STRICTLY PROHIBITED. NSD, INC. MAINTAINS OWNERSHIP OF SAME. THIS PROHIBITION EXTENDS FROM PRINTED MATERIAL TO ANY ELECTRONIC VERSION OF THE SAME. NO USE, OTHER THAN THAT FOR WHICH IT IS INTENDED, IS STRICTLY PROHIBITED WITHOUT WRITTEN PERMISSION FROM NEXT STEP DESIGN,INC. ALL RIGHTS RESERVED.

SUBMITTAL DATE

~

~

~

~

~


~

~



Market

E Marke

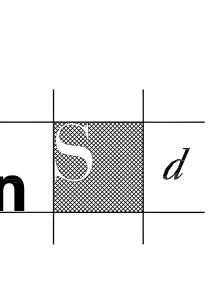

PANEL FOR WATER
FILTER ACCESS

SECTION 1 SCALE: 3/4"=1'-0" Next Step Design

913 West Street, Suite A Annapolis, MD 21401

Ph: (410) 263-1200 Fx: (410) 280-1340 www.nextstepdesign.com


DATE: SCALE:


AS NOTED


PROJECT #: DRAWN:
D-9175 JRLS

FOODSERVICE FABRICATION ELEVATIONS


FS-T1-EL2

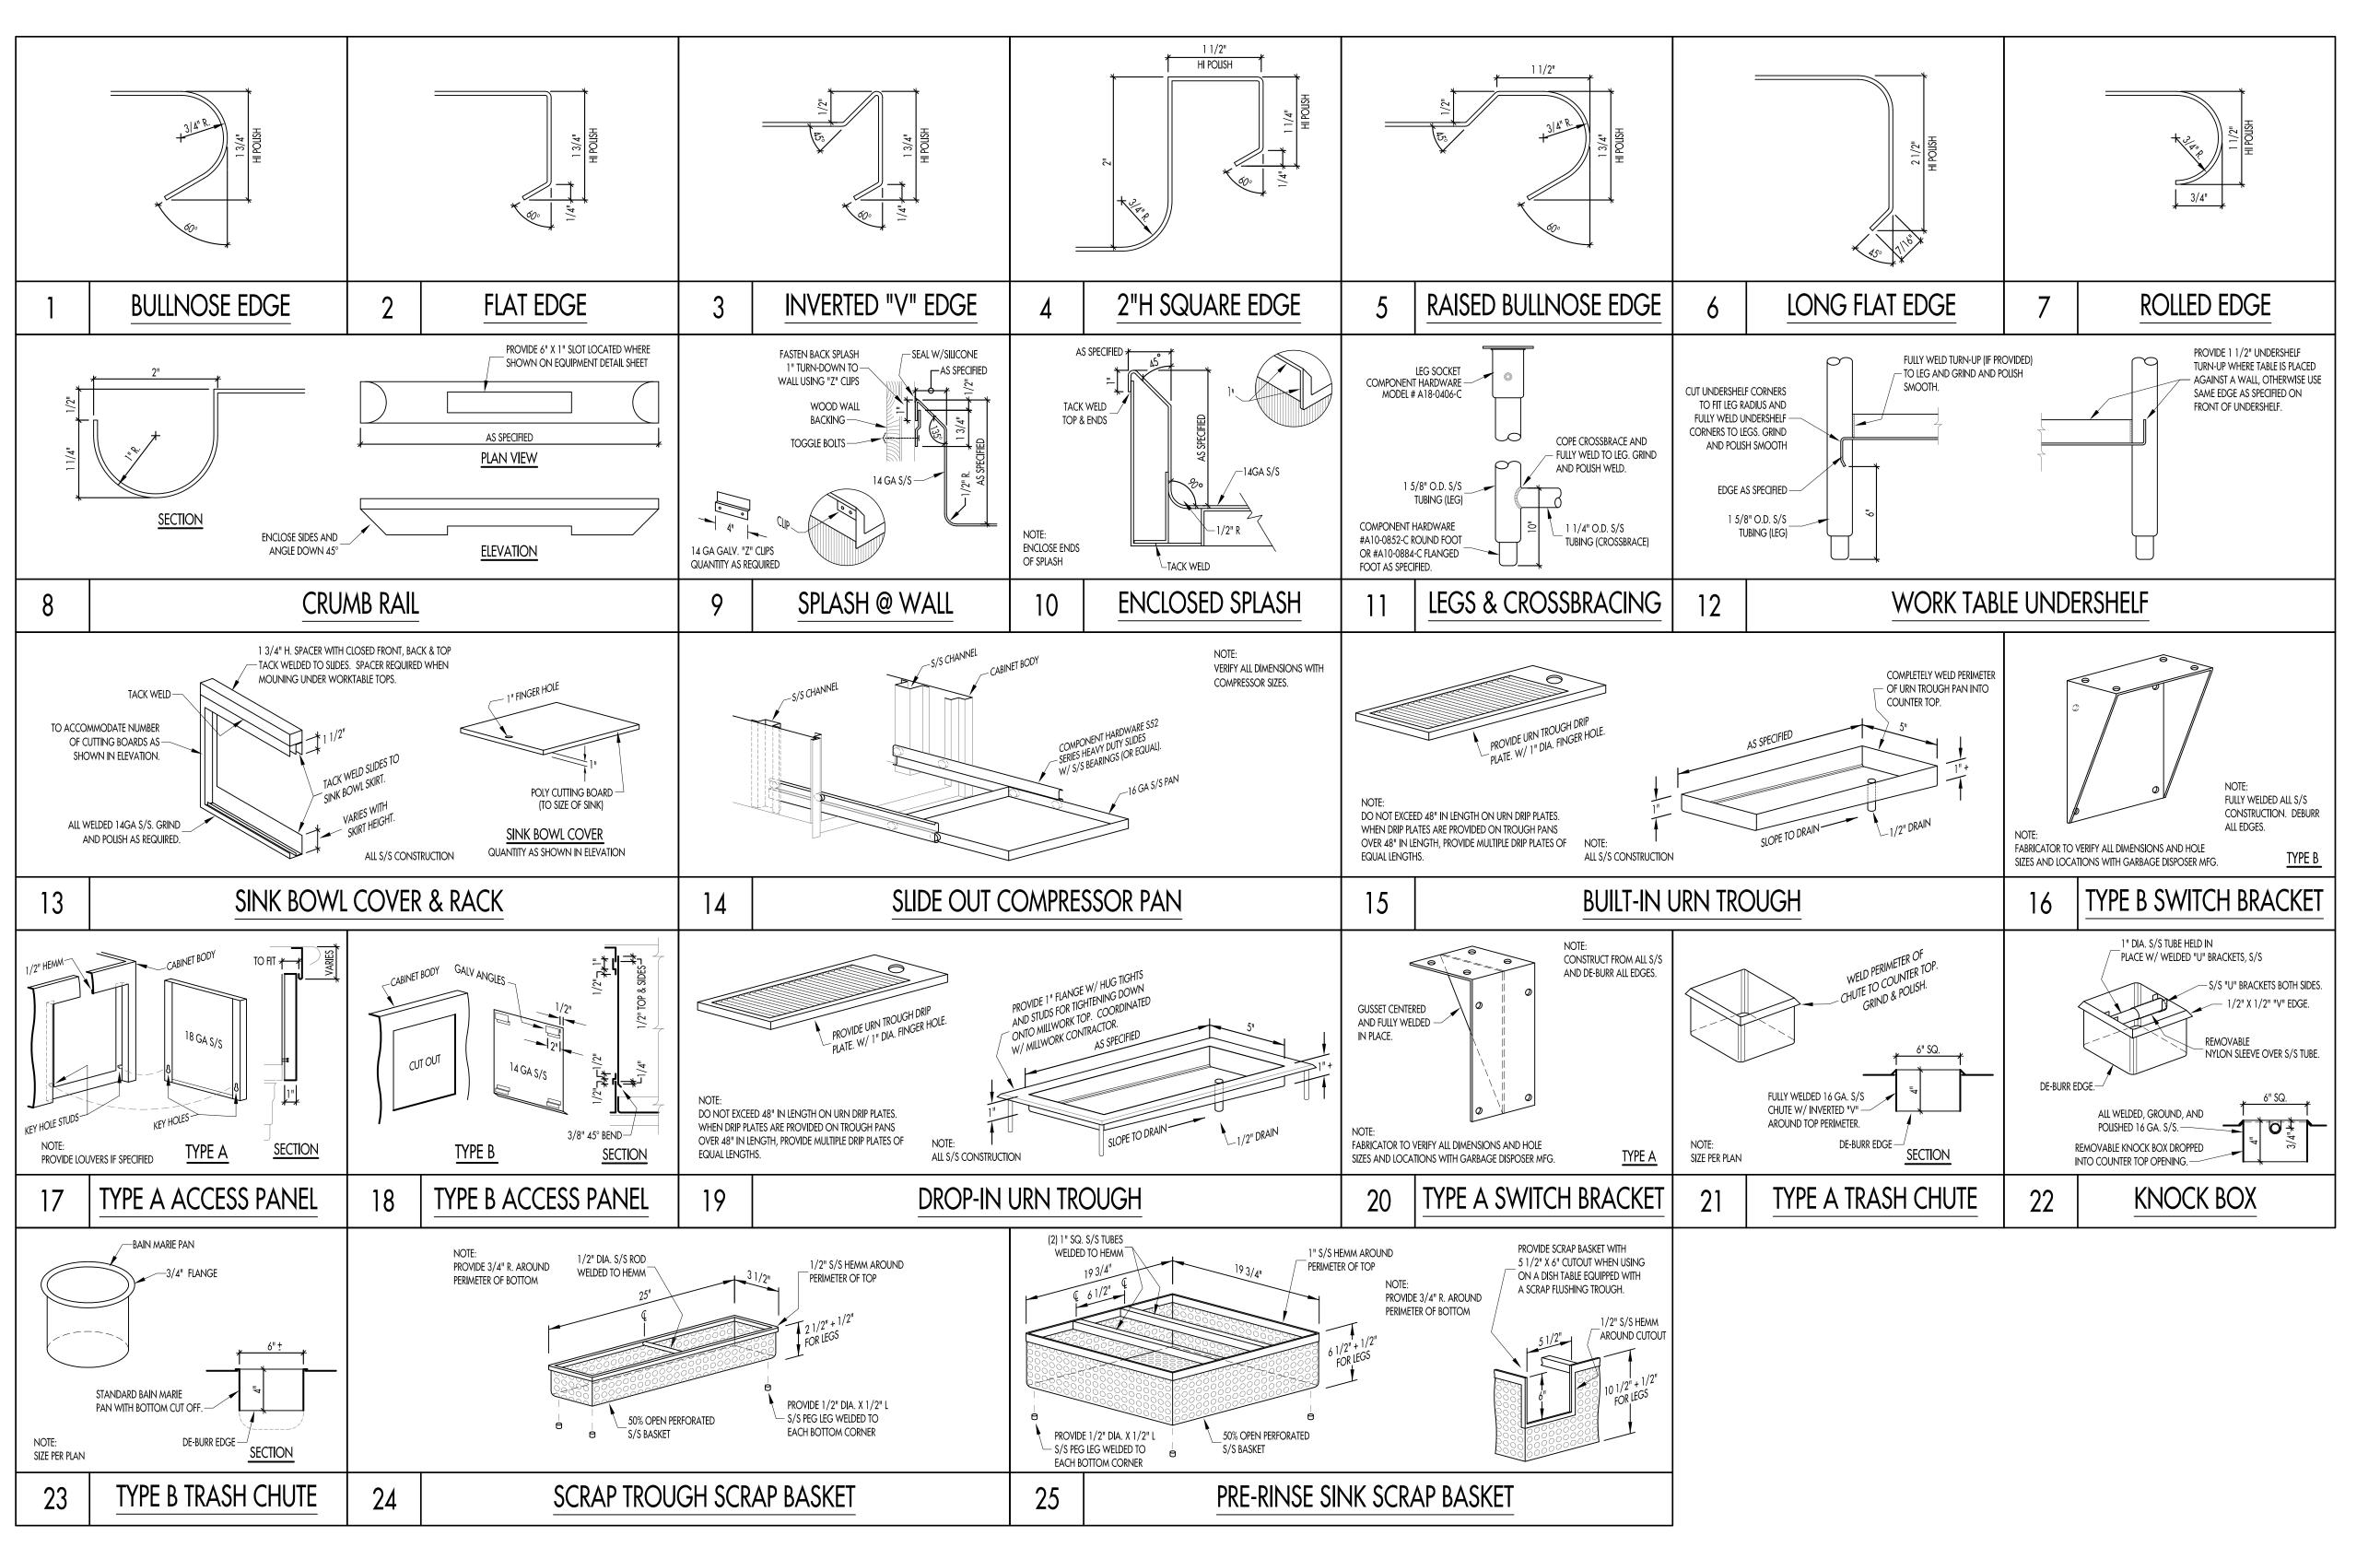

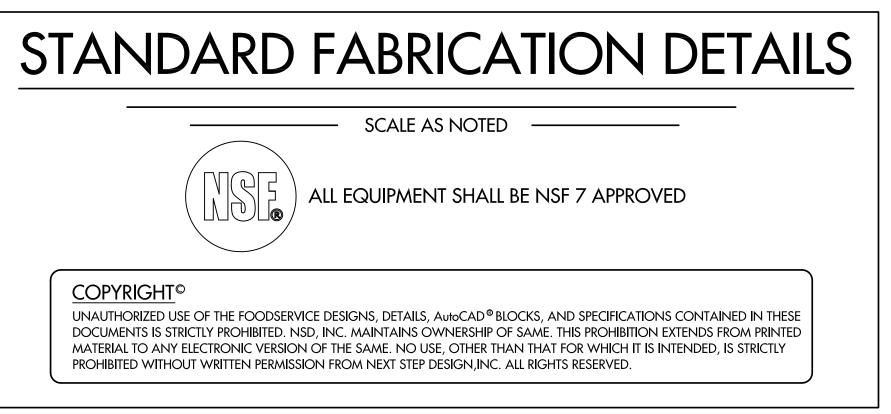

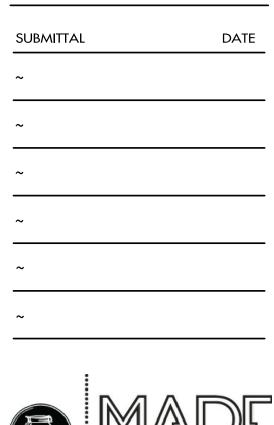



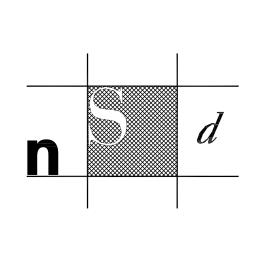

Next Step Design FOODSERVICE CONSULTANTS


913 West Street, Suite A Annapolis, MD 21401

> Ph: (410) 263-1200 Fx: (410) 280-1340 www.nextstepdesign.com

DATE: SCALE: AS NOTED


PROJECT #: DRAWN: D-91*75* **JRLS**

> **FOODSERVICE** FABRICATION DETAILS

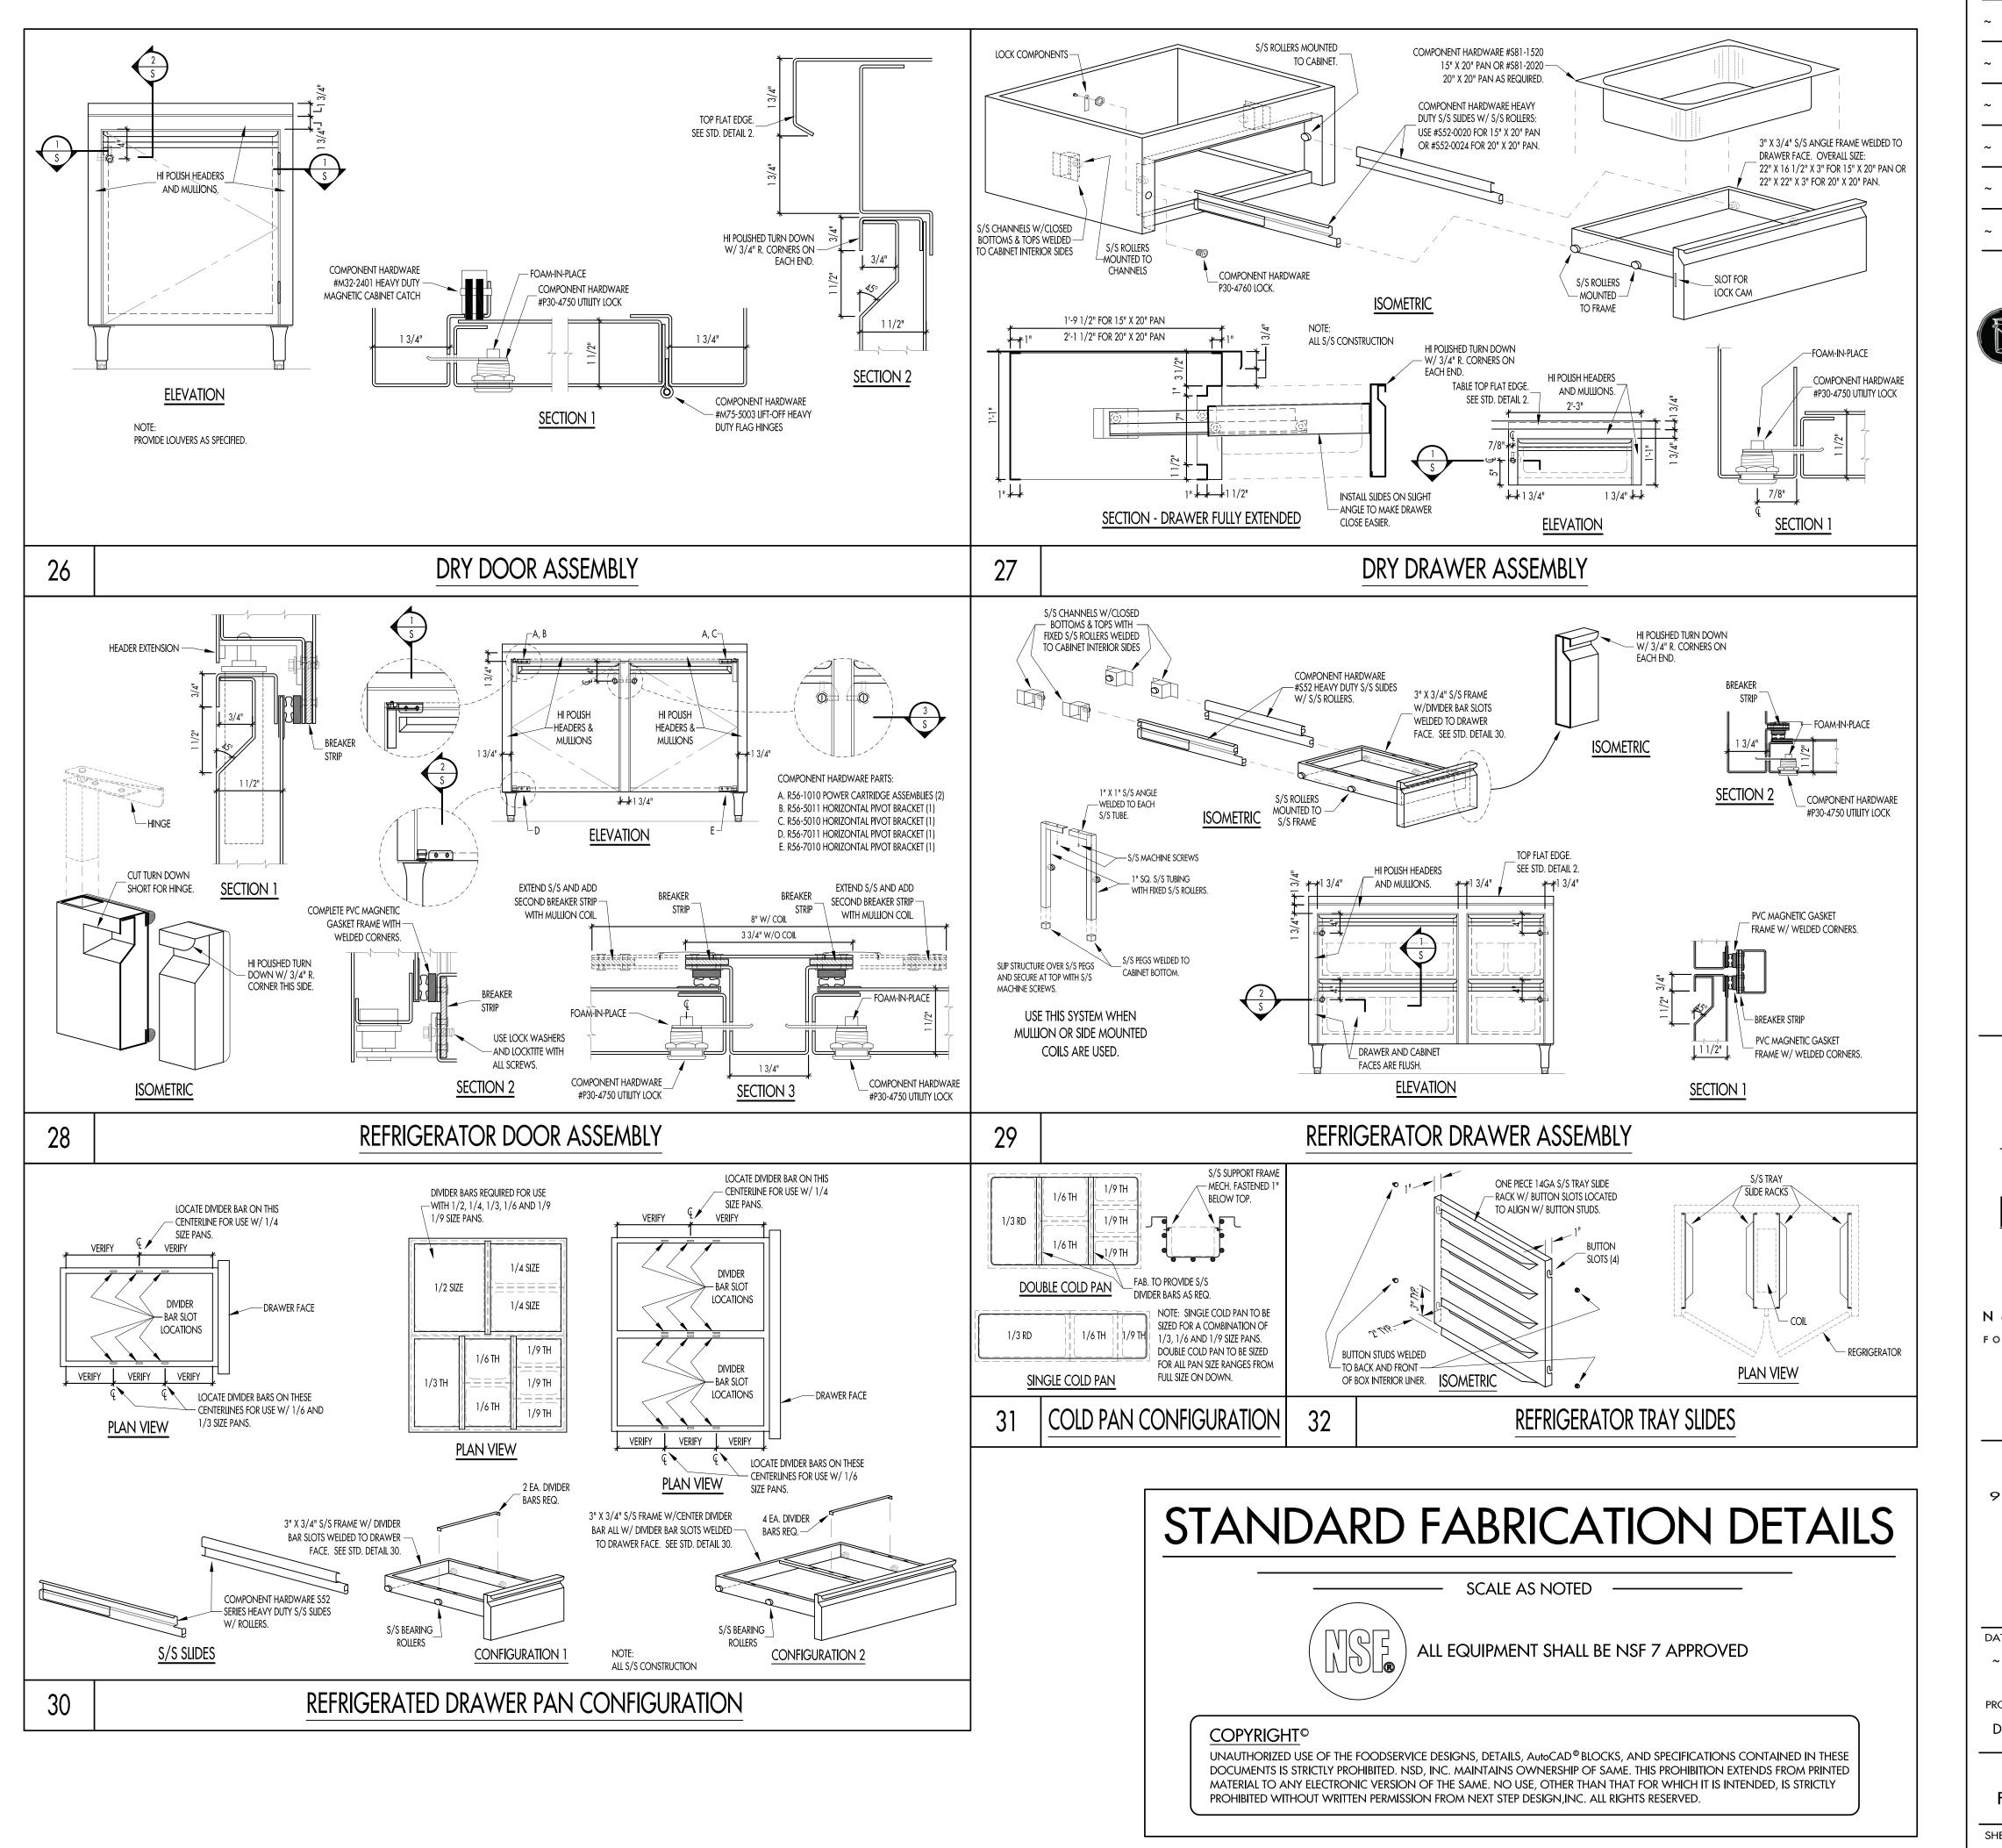

SUBMITTAL DATE



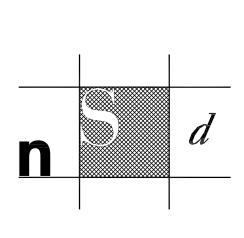

Next Step Design FOODSERVICE CONSULTANTS

913 West Street, Suite A Annapolis, MD 21401


> Ph: (410) 263-1200 Fx: (410) 280-1340 www.nextstepdesign.com


DATE: SCALE: AS NOTED


PROJECT #: DRAWN: D-91*75*

> **FOODSERVICE** FABRICATION DETAILS

JRLS

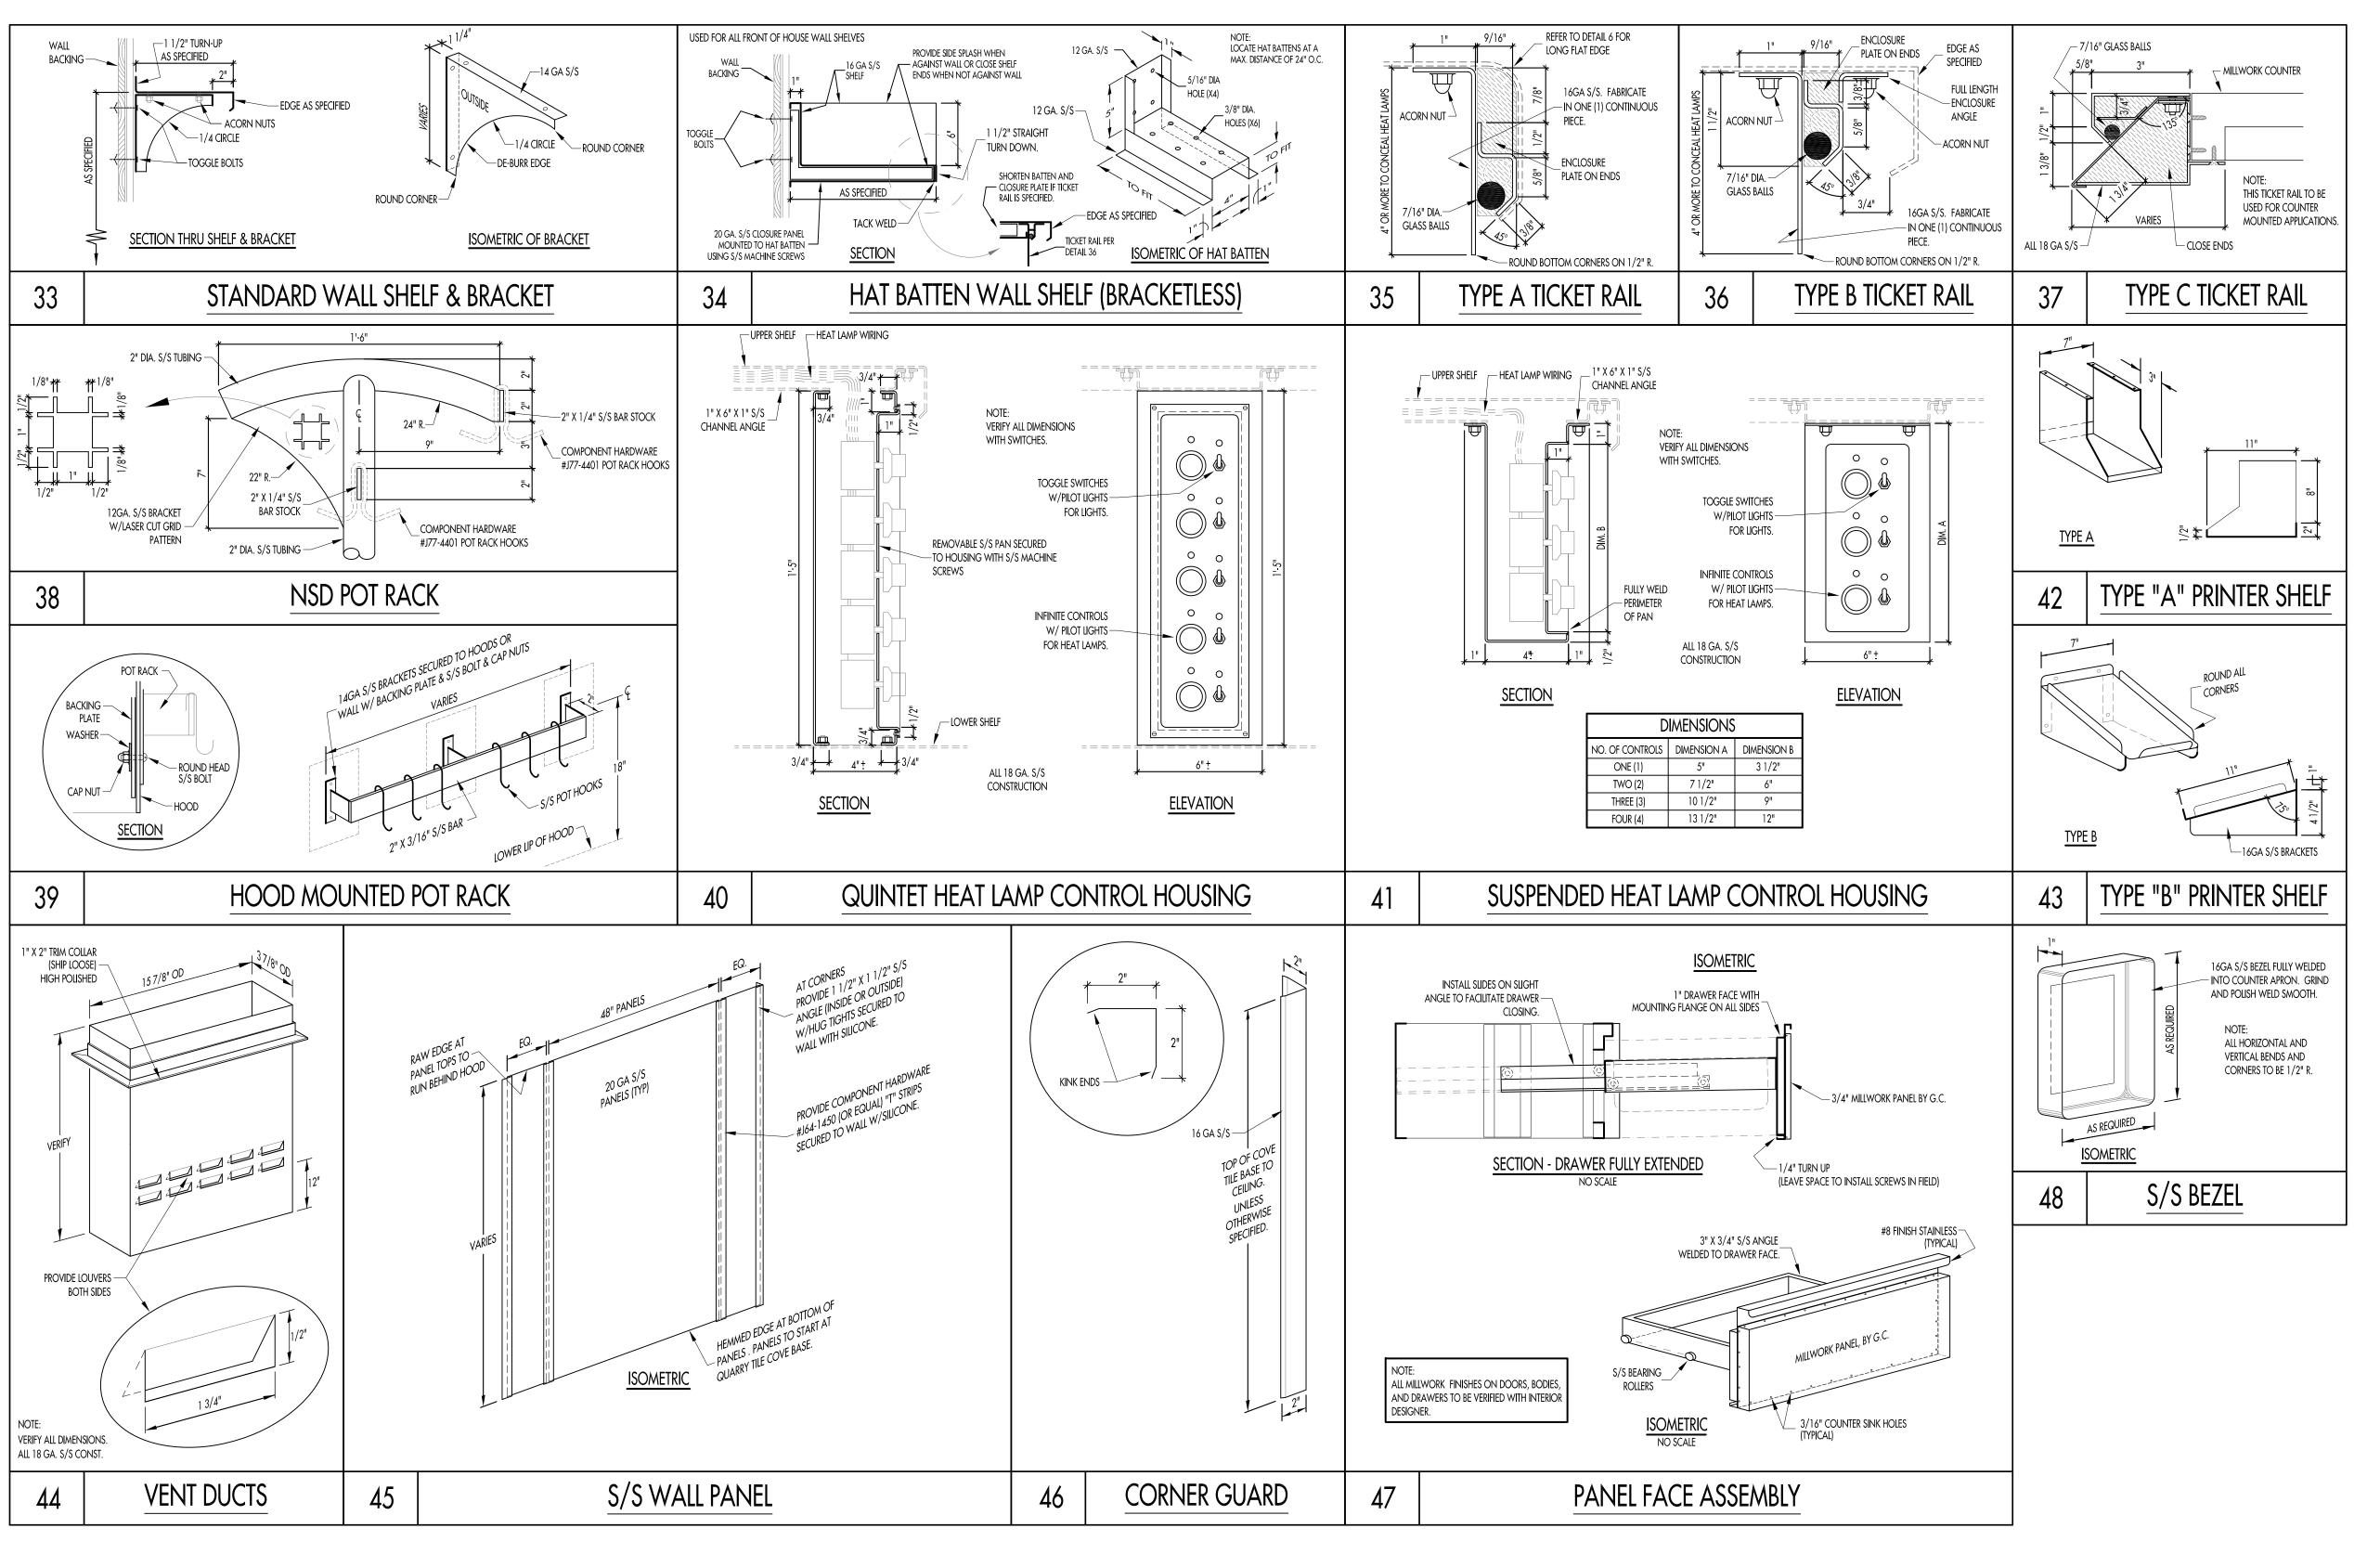


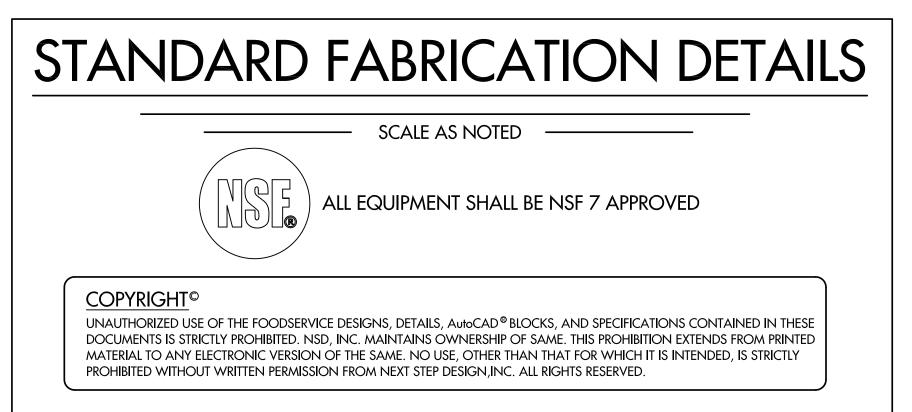

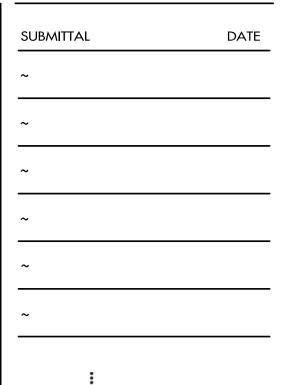



AADE Market

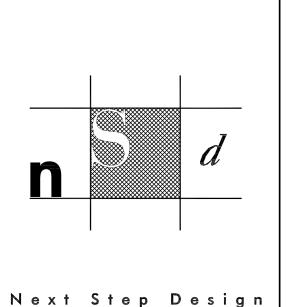

FOODSERVICE CONSULTANTS

913 West Street, Suite A Annapolis, MD 21401


> Ph: (410) 263-1200 Fx: (410) 280-1340 www.nextstepdesign.com


DATE: SCALE:


~ AS NOTED


PROJECT #: DRAWN:
D-9175 JRLS

FOODSERVICE FABRICATION DETAILS

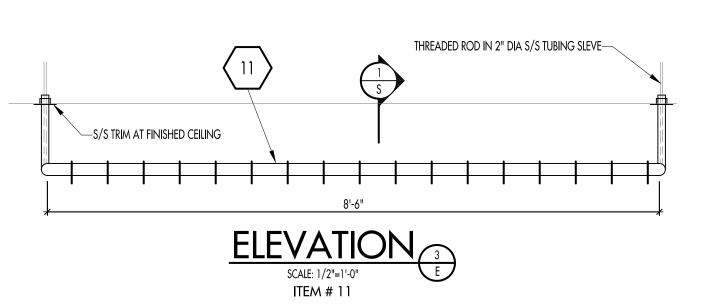

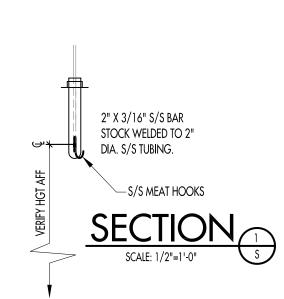

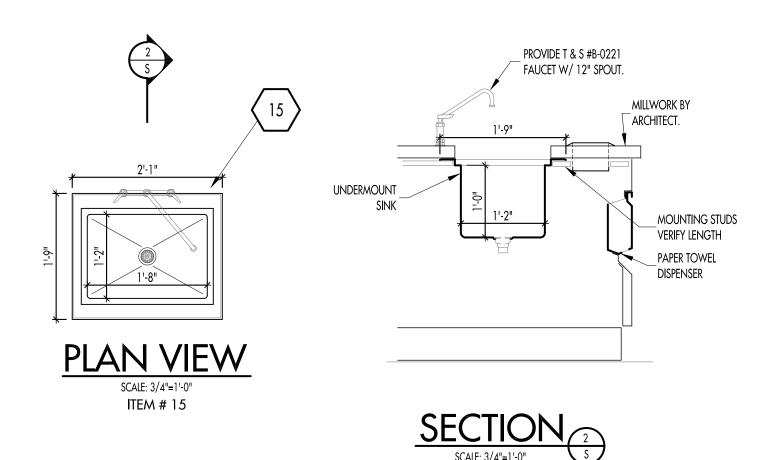

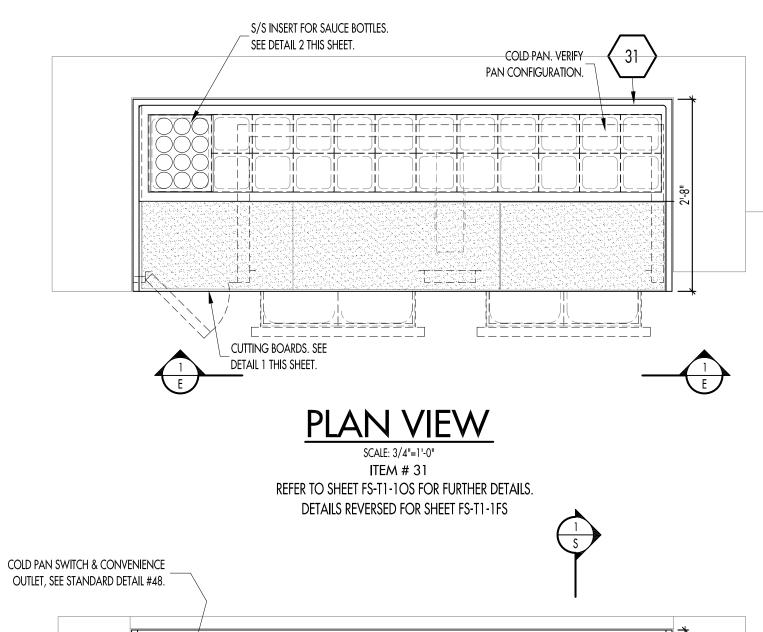

TWO FULL SIZE PAN

TWO FULL SIZE PAN


REFRIGERATOR


REFRIG UTILITY
COMPARTMENT

DOOR. SEE STD DETAIL 26.





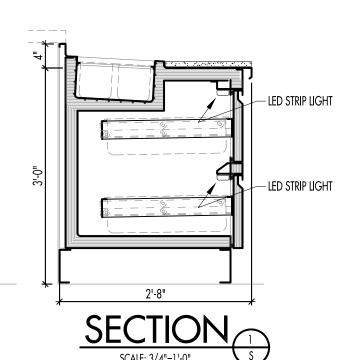

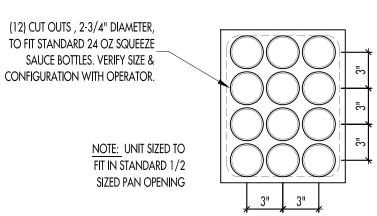



FABRICATION DETAILS

TWO FULL SIZE PAN

TWO FULL SIZE PAN

REFRIGERATOR

SCALE AS NOTED

NOTE:
FABRICATORS ARE RESPONSIBLE FOR OBTAINING THEIR OWN
FIELD DIMENSIONS, LOCATIONS OF ANY REQUIRED FIELD JOINTS,
AND FOR VERIFYING ALL CUTOUT AND OPENING DIMENSIONS

COPYRIGHT®

UNAUTHORIZED USE OF THE FOODSERVICE DESIGNS, DETAILS, AutoCAD® BLOCKS, AND SPECIFICATIONS CONTAINED IN THESE DOCUMENTS IS STRICTLY PROHIBITED. NSD, INC. MAINTAINS OWNERSHIP OF SAME. THIS PROHIBITION EXTENDS FROM PRINTED MATERIAL TO ANY ELECTRONIC VERSION OF THE SAME. NO USE, OTHER THAN THAT FOR WHICH IT IS INTENDED, IS STRICTLY PROHIBITED WITHOUT WRITTEN PERMISSION FROM NEXT STEP DESIGN,INC. ALL RIGHTS RESERVED.

SHOWN ON THESE DRAWINGS.

REFRIGERATION NOTES:

- . ALL FABRICATED COUNTERS WITH REFRIGERATION WILL BE CONSTRUCTED TO CONFORM TO AND BEAR NSF #7 LABEL (OR EQUIVALENT) FOR PERFORMANCE. ALL CABINETS WILL BE CONSTRUCTED TO MEET ALL GENERAL NSF FABRICATION STANDARDS.
- 2. REMOTE REFRIGERATED FABRICATED EQUIPMENT SHALL BE PROVIDED WITH EVAPORATOR COIL, THERMOSTATIC EXPANSION VALVE, THERMOSTATIC CONTROL AND SOLENOID VALVE FABRICATOR MOUNTED, PRE-WIRED AND PRE-PIPED TO UTILITY COMPARTMENT AS DESIGNATED IN FABRICATION DRAWINGS.
- 3. ALL REMOTE REFRIGERATED BASES TO BE PROVIDED WITH ON-OFF SWITCH LOCATED IN THE UTILITY COMPARTMENT FOR SERVICE OF EVAPORATOR AND CONTROLS.
- 4. REFRIGERATED EQUIPMENT BASES TO BE COMPLETELY PRE-WIRED, INCLUDING LIGHTS AND CONDENSATE HEATERS TO THE UTILITY COMPARTMENT AS DESIGNATED IN THE FABRICATED DRAWINGS.
- 5. ALL SELF-CONTAINED FABRICATED EQUIPMENT WILL CONFORM TO THE ABOVE STANDARDS AND BE PROVIDED WITH CAP AND CORD FOR CONDENSING UNIT DISCONNECT WITH RECEPTACLE AT ELECTRICAL JUNCTION BOX IN UTILITY COMPARTMENT.
- 6. ALL SELF-CONTAINED BASES WILL BE PROVIDED WITH CONDENSATE EVAPORATORS, UNLESS OTHERWISE NOTED IN THE DRAWINGS.
- 7. ALL REFRIGERATED BASES TO BE PROVIDED WITH 2" DIAL THERMOMETER FACE MOUNTED.
- 3. MECHANICAL COLD PAN(S) SHALL BE SUPPLIED AND INSTALLED BY FABRICATOR.

 CONTROL(S) FOR COLD PAN(S) SHALL BE LOCATED IN REFRIGERATION UTILITY

 COMPARTMENT AS DESIGNATED IN FABRICATION DRAWINGS.

CONSTRUCTION NOTES:

- . UNLESS OTHERWISE NOTED, METAL GAUGES SHALL BE AS FOLLOWS:
 A. BASES, INCLUDING EXTERIOR AND INTERIOR WRAPS AND PANELS AND FACES
- OF DOORS, DRAWERS, AND ACCESS PANELS TO BE 18GA S/S
- B. TOPS, SINK BOWLS, AND SPLASHES TO BE 14GA S/S C. WALL AND TABLE MOUNTED SHELVES TO BE 16GA S/S. WALL SHELVES TO
- BE SUPPORTED USING 14GA S/S BRACKETS. TABLE MOUNTED SHELVES TO BE SUPPORTED USING 1 5/8" ROUND S/S TUBING AND 14GA S/S GUSSETS.
- D. WALL CABINET WRAPS AND DOOR FACES TO BE 18GA S/S. INTERIOR SHELVES TO BE 16GA S/S.
- E. INTERIOR REFRIGERATOR, FREEZER, & HEATED CABINET WRAPS TO BE 20GA S/S.
- F. OPEN CABINET BASE & WORK TABLE UNDERSHELVES TO BE 16GA S/S.
- 2. UNLESS OTHERWISE NOTED, ALL EDGES SHALL BE AS FOLLOWS:
 A. COUNTER TOPS: FLAT EDGE DETAIL 2
- B. CHEF COUNTER DOUBLE PASS-OVER SHELVES: LONG FLAT EDGE DETAIL 6
- C. UNDERSHELVES: FLAT EDGE DETAIL 2 D. WALL SHELVES: FLAT EDGE - DETAIL 2
- FULL HEIGHT LEGS CONSTRUCTED FROM 1 5/8" DIA. S/S TUBING W/ ADJ. S/S HEX SHAPED OR FLANGED FEET AS SHOWN. LEGS SECURED TO TABLE USING S/S LEG SOCKETS W/ LOCKING SET SCREWS. SOCKETS WELDED TO UNDERSIDE OF TABLE.
- 4. CROSSBRACING TO BE 1 1/4" DIA. S/S TUBING.
- 5. 6" LEGS TO BE COMPONENT HARDWARE #A77-5048-C W/ FLANGE FOR WELDING
- 6. ALL EXPOSED CHANNEL FRAMING TO BE 14GA S/S. USE 14GA GALV. OTHERWISE.
- 7. ALL CUTTING BOARDS TO BE 3/4" THICK AND MANUFACTURED BY RICHLITE.
- PROVIDE SOUND DEADENING MATERIAL ON UNDERSIDE OF ALL TOPS.
 PROVIDE (1) ORANGE FACE S.R. SINGLE RECEPTACLE FOR PRINTER AND (1) EMPTY
 J.B. FOR POS DATA CABLE. USE COMPONENT HARDWARE #R58-1010. RUN
 (CONCEALED) CONDUIT W/ PULL STRING FROM EACH PRINTER DATA BOX TO SUB
- PANEL COMPARTMENT.

 10. PROVIDE DRAWERS AND DOORS WITH LOCKS AND PROVIDE SINGLE KEY TO FIT ALL. SEE DETAILS 26, 27, 28, & 29.
- 1. FABRICATOR TO PROVIDE ELECTRICAL SUB-PANEL WHERE DESIGNATED, PROVIDE AND INSTALL ALL ELECTRICAL BOXES AND OUTLETS, AND PRE-WIRE ENTIRE COUNTER TO ELECTRICAL SUB-PANEL. FABRICATOR TO MAKE COUNTER READY FOR FINAL SINGLE POINT CONNECTION. FABRICATOR TO PROVIDE U.L.. TESTING.

SUBMITTAL DATE

~

~

IER 1

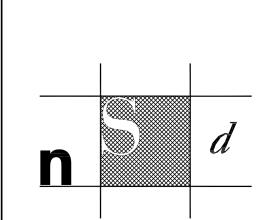

Next Step Design

913 West Street, Suite A Annapolis, MD 21401

Ph: (410) 263-1200 Fx: (410) 280-1340

www.nextstepdesign.com


SCALE:


~ AS NOTED


PROJECT #: DRAWN:
D-9175 JRLS


DATE:

FOODSERVICE FABRICATION DETAILS

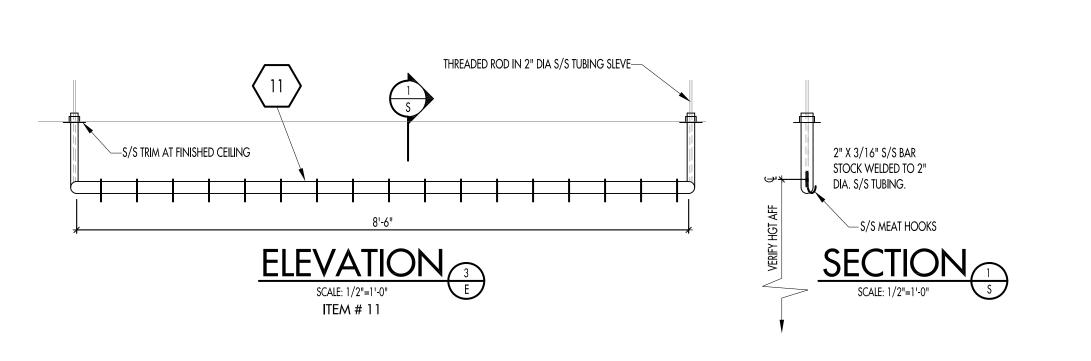

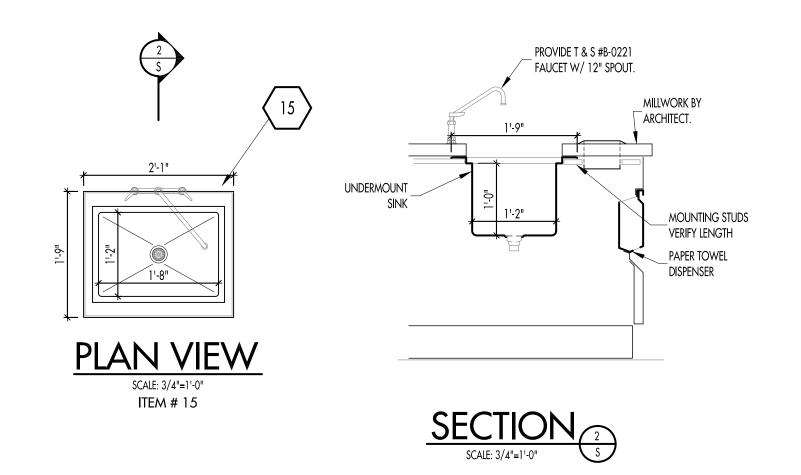


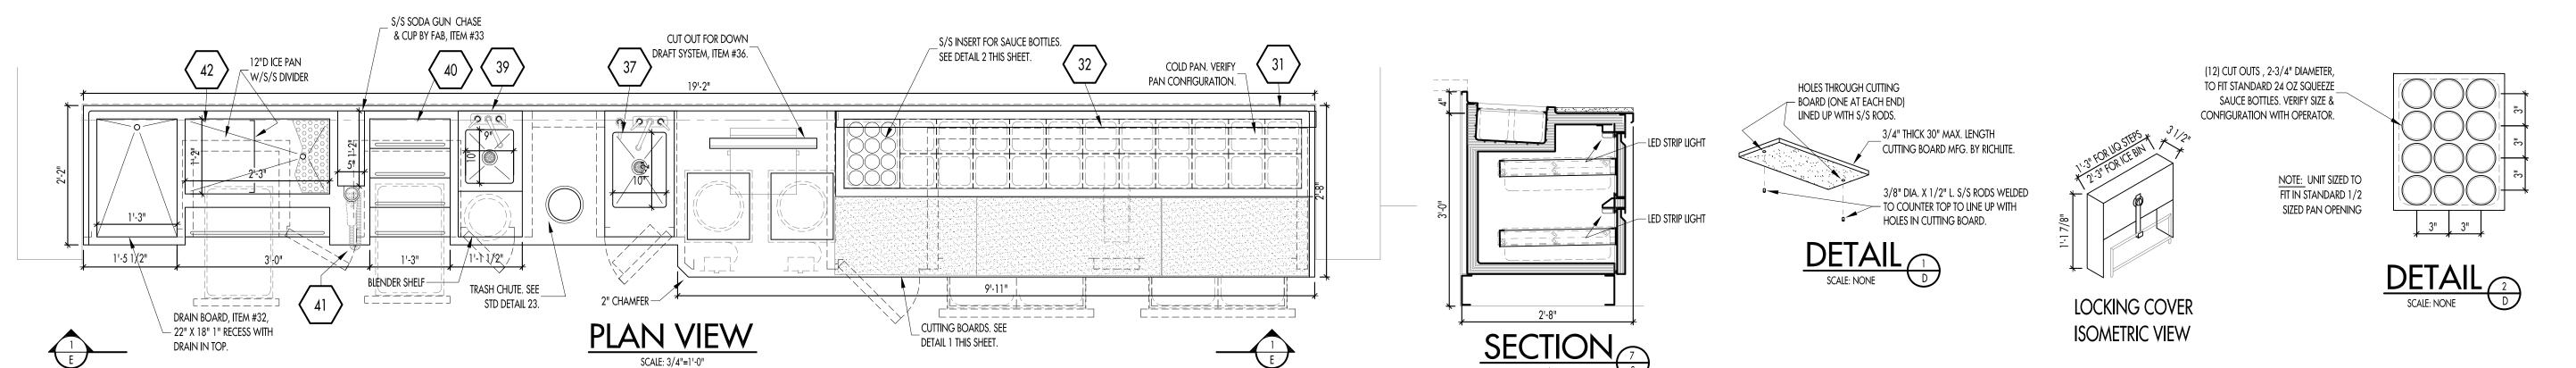

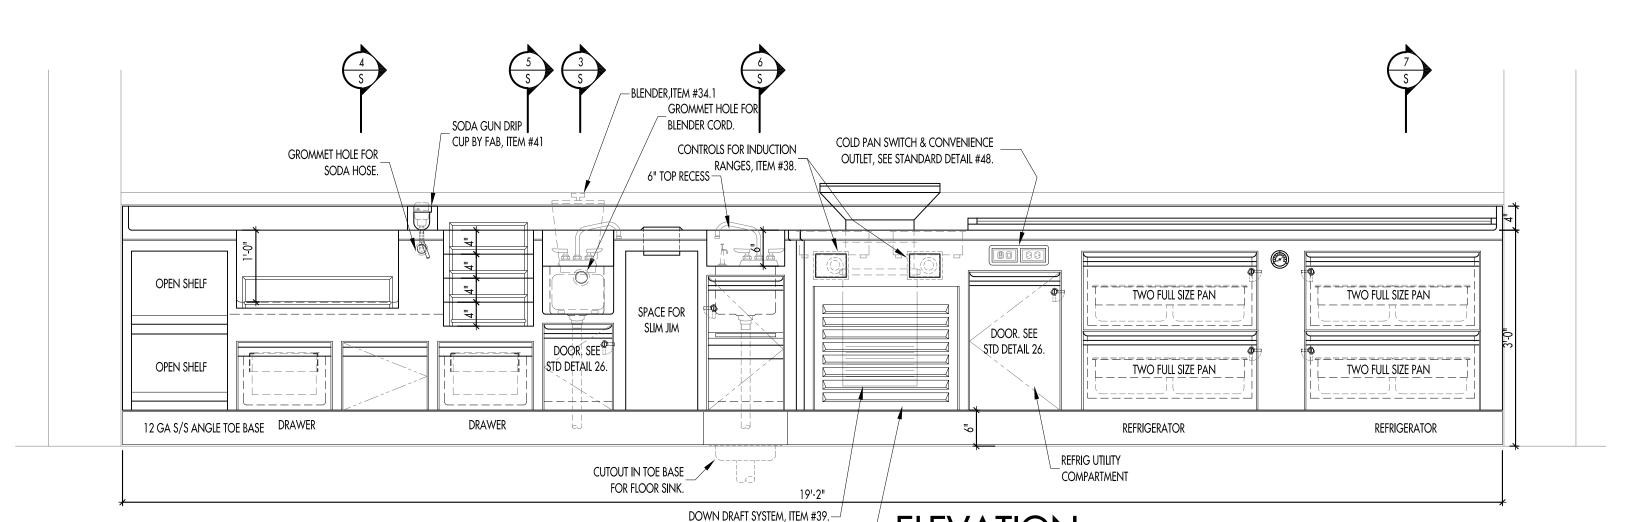

LOUVERED ACCESS PANEL

ITEM # 31, 32, 37, 39, 40 & 42

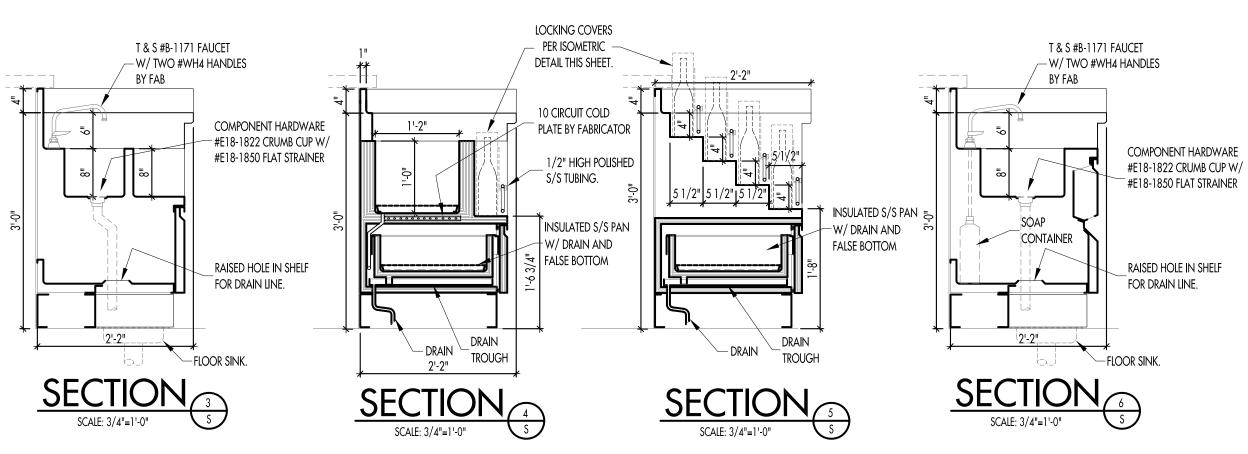

CONFORM TO AND BEAR NSF #7 LABEL (OR EQUIVALENT) FOR PERFORMANCE. ALL CABINETS WILL BE CONSTRUCTED TO MEET ALL GENERAL NSF FABRICATION STANDARDS.

> 2. REMOTE REFRIGERATED FABRICATED EQUIPMENT SHALL BE PROVIDED WITH EVAPORATOR COIL, THERMOSTATIC EXPANSION VALVE, THERMOSTATIC CONTROL AND SOLENOID VALVE - FABRICATOR MOUNTED, PRE-WIRED AND PRE-PIPED TO UTILITY COMPARTMENT AS DESIGNATED IN FABRICATION DRAWINGS.

REFRIGERATION NOTES:

. ALL FABRICATED COUNTERS WITH REFRIGERATION WILL BE CONSTRUCTED TO

. ALL REMOTE REFRIGERATED BASES TO BE PROVIDED WITH ON-OFF SWITCH LOCATED IN THE UTILITY COMPARTMENT FOR SERVICE OF EVAPORATOR AND CONTROLS.

I. REFRIGERATED EQUIPMENT BASES TO BE COMPLETELY PRE-WIRED, INCLUDING LIGHTS AND CONDENSATE HEATERS TO THE UTILITY COMPARTMENT AS DESIGNATED IN THE FABRICATED DRAWINGS.

. ALL SELF-CONTAINED FABRICATED EQUIPMENT WILL CONFORM TO THE ABOVE STANDARDS AND BE PROVIDED WITH CAP AND CORD FOR CONDENSING UNIT DISCONNECT WITH RECEPTACLE AT ELECTRICAL JUNCTION BOX IN UTILITY COMPARTMENT.

ALL SELF-CONTAINED BASES WILL BE PROVIDED WITH CONDENSATE EVAPORATORS, UNLESS OTHERWISE NOTED IN THE DRAWINGS.

ALL REFRIGERATED BASES TO BE PROVIDED WITH 2" DIAL THERMOMETER FACE MOUNTED.

. MECHANICAL COLD PAN(S) SHALL BE SUPPLIED AND INSTALLED BY FABRICATOR. CONTROL(S) FOR COLD PAN(S) SHALL BE LOCATED IN REFRIGERATION UTILITY COMPARTMENT AS DESIGNATED IN FABRICATION DRAWINGS.

CONSTRUCTION NOTES:

- . UNLESS OTHERWISE NOTED, METAL GAUGES SHALL BE AS FOLLOWS: A. BASES, INCLUDING EXTERIOR AND INTERIOR WRAPS AND PANELS AND FACES OF DOORS, DRAWERS, AND ACCESS PANELS TO BE 18GA S/S
- B. TOPS, SINK BOWLS, AND SPLASHES TO BE 14GA S/S C. WALL AND TABLE MOUNTED SHELVES TO BE 16GA S/S. WALL SHELVES TO
- BE SUPPORTED USING 14GA S/S BRACKETS. TABLE MOUNTED SHELVES TO BE SUPPORTED USING 1 5/8" ROUND S/S TUBING AND 14GA S/S GUSSETS. D. WALL CABINET WRAPS AND DOOR FACES TO BE 18GA S/S. INTERIOR
- SHELVES TO BE 16GA S/S. E. INTERIOR REFRIGERATOR, FREEZER, & HEATED CABINET WRAPS TO BE 20GA S/S.
- F. OPEN CABINET BASE & WORK TABLE UNDERSHELVES TO BE 16GA S/S. . UNLESS OTHERWISE NOTED, ALL EDGES SHALL BE AS FOLLOWS:
- A. COUNTER TOPS: FLAT EDGE DETAIL 2 B. CHEF COUNTER DOUBLE PASS-OVER SHELVES: LONG FLAT EDGE - DETAIL 6
- C. UNDERSHELVES: FLAT EDGE DETAIL 2
- D. WALL SHELVES: FLAT EDGE DETAIL 2
- 3. FULL HEIGHT LEGS CONSTRUCTED FROM 1 5/8" DIA. S/S TUBING W/ ADJ. S/S HEX SHAPED OR FLANGED FEET AS SHOWN. LEGS SECURED TO TABLE USING S/S LEG SOCKETS W/ LOCKING SET SCREWS. SOCKETS WELDED TO UNDERSIDE OF TABLE.
- 4. CROSSBRACING TO BE 1 1/4" DIA. S/S TUBING.


PANEL COMPARTMENT.

- 5. 6" LEGS TO BE COMPONENT HARDWARE #A77-5048-C W/ FLANGE FOR WELDING.
- 6. ALL EXPOSED CHANNEL FRAMING TO BE 14GA S/S. USE 14GA GALV. OTHERWISE.
- 7. ALL CUTTING BOARDS TO BE 3/4" THICK AND MANUFACTURED BY RICHLITE.
- 8. PROVIDE SOUND DEADENING MATERIAL ON UNDERSIDE OF ALL TOPS. P. PROVIDE (1) ORANGE FACE S.R. SINGLE RECEPTACLE FOR PRINTER AND (1) EMPTY J.B. FOR POS DATA CABLE. USE COMPONENT HARDWARE #R58-1010. RUN (CONCEALED) CONDUIT W/ PULL STRING FROM EACH PRINTER DATA BOX TO SUB
- 0. PROVIDE DRAWERS AND DOORS WITH LOCKS AND PROVIDE SINGLE KEY TO FIT
- ALL. SEE DETAILS 26, 27, 28, & 29. . FABRICATOR TO PROVIDE ELECTRICAL SUB-PANEL WHERE DESIGNATED, PROVIDE AND INSTALL ALL ELECTRICAL BOXES AND OUTLETS, AND PRE-WIRE ENTIRE COUNTER TO ELECTRICAL SUB-PANEL. FABRICATOR TO MAKE COUNTER READY FOR FINAL SINGLE POINT CONNECTION. FABRICATOR TO PROVIDE U.L., TESTING.

DATE

SUBMITTAL



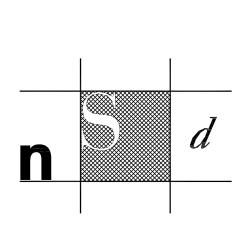

Next Step Design FOODSERVICE CONSULTANTS

913 West Street, Suite A Annapolis, MD 21401

> Ph: (410) 263-1200 Fx: (410) 280-1340

www.nextstepdesign.com

DATE: SCALE: AS NOTED

PROJECT #: DRAWN: D-91*75* JRLS

> **FOODSERVICE** FABRICATION DETAILS

FS-T1-FAB5

FABRICATION DETAILS

SCALE AS NOTED


FABRICATORS ARE RESPONSIBLE FOR OBTAINING THEIR OWN FIELD DIMENSIONS, LOCATIONS OF ANY REQUIRED FIELD JOINTS,

AND FOR VERIFYING ALL CUTOUT AND OPENING DIMENSIONS

COPYRIGHT©

UNAUTHORIZED USE OF THE FOODSERVICE DESIGNS, DETAILS, AutoCAD® BLOCKS, AND SPECIFICATIONS CONTAINED IN THESE DOCUMENTS IS STRICTLY PROHIBITED. NSD, INC. MAINTAINS OWNERSHIP OF SAME. THIS PROHIBITION EXTENDS FROM PRINTED MATERIAL TO ANY ELECTRONIC VERSION OF THE SAME. NO USE, OTHER THAN THAT FOR WHICH IT IS INTENDED, IS STRICTLY PROHIBITED WITHOUT WRITTEN PERMISSION FROM NEXT STEP DESIGN, INC. ALL RIGHTS RESERVED.

SHOWN ON THESE DRAWINGS.

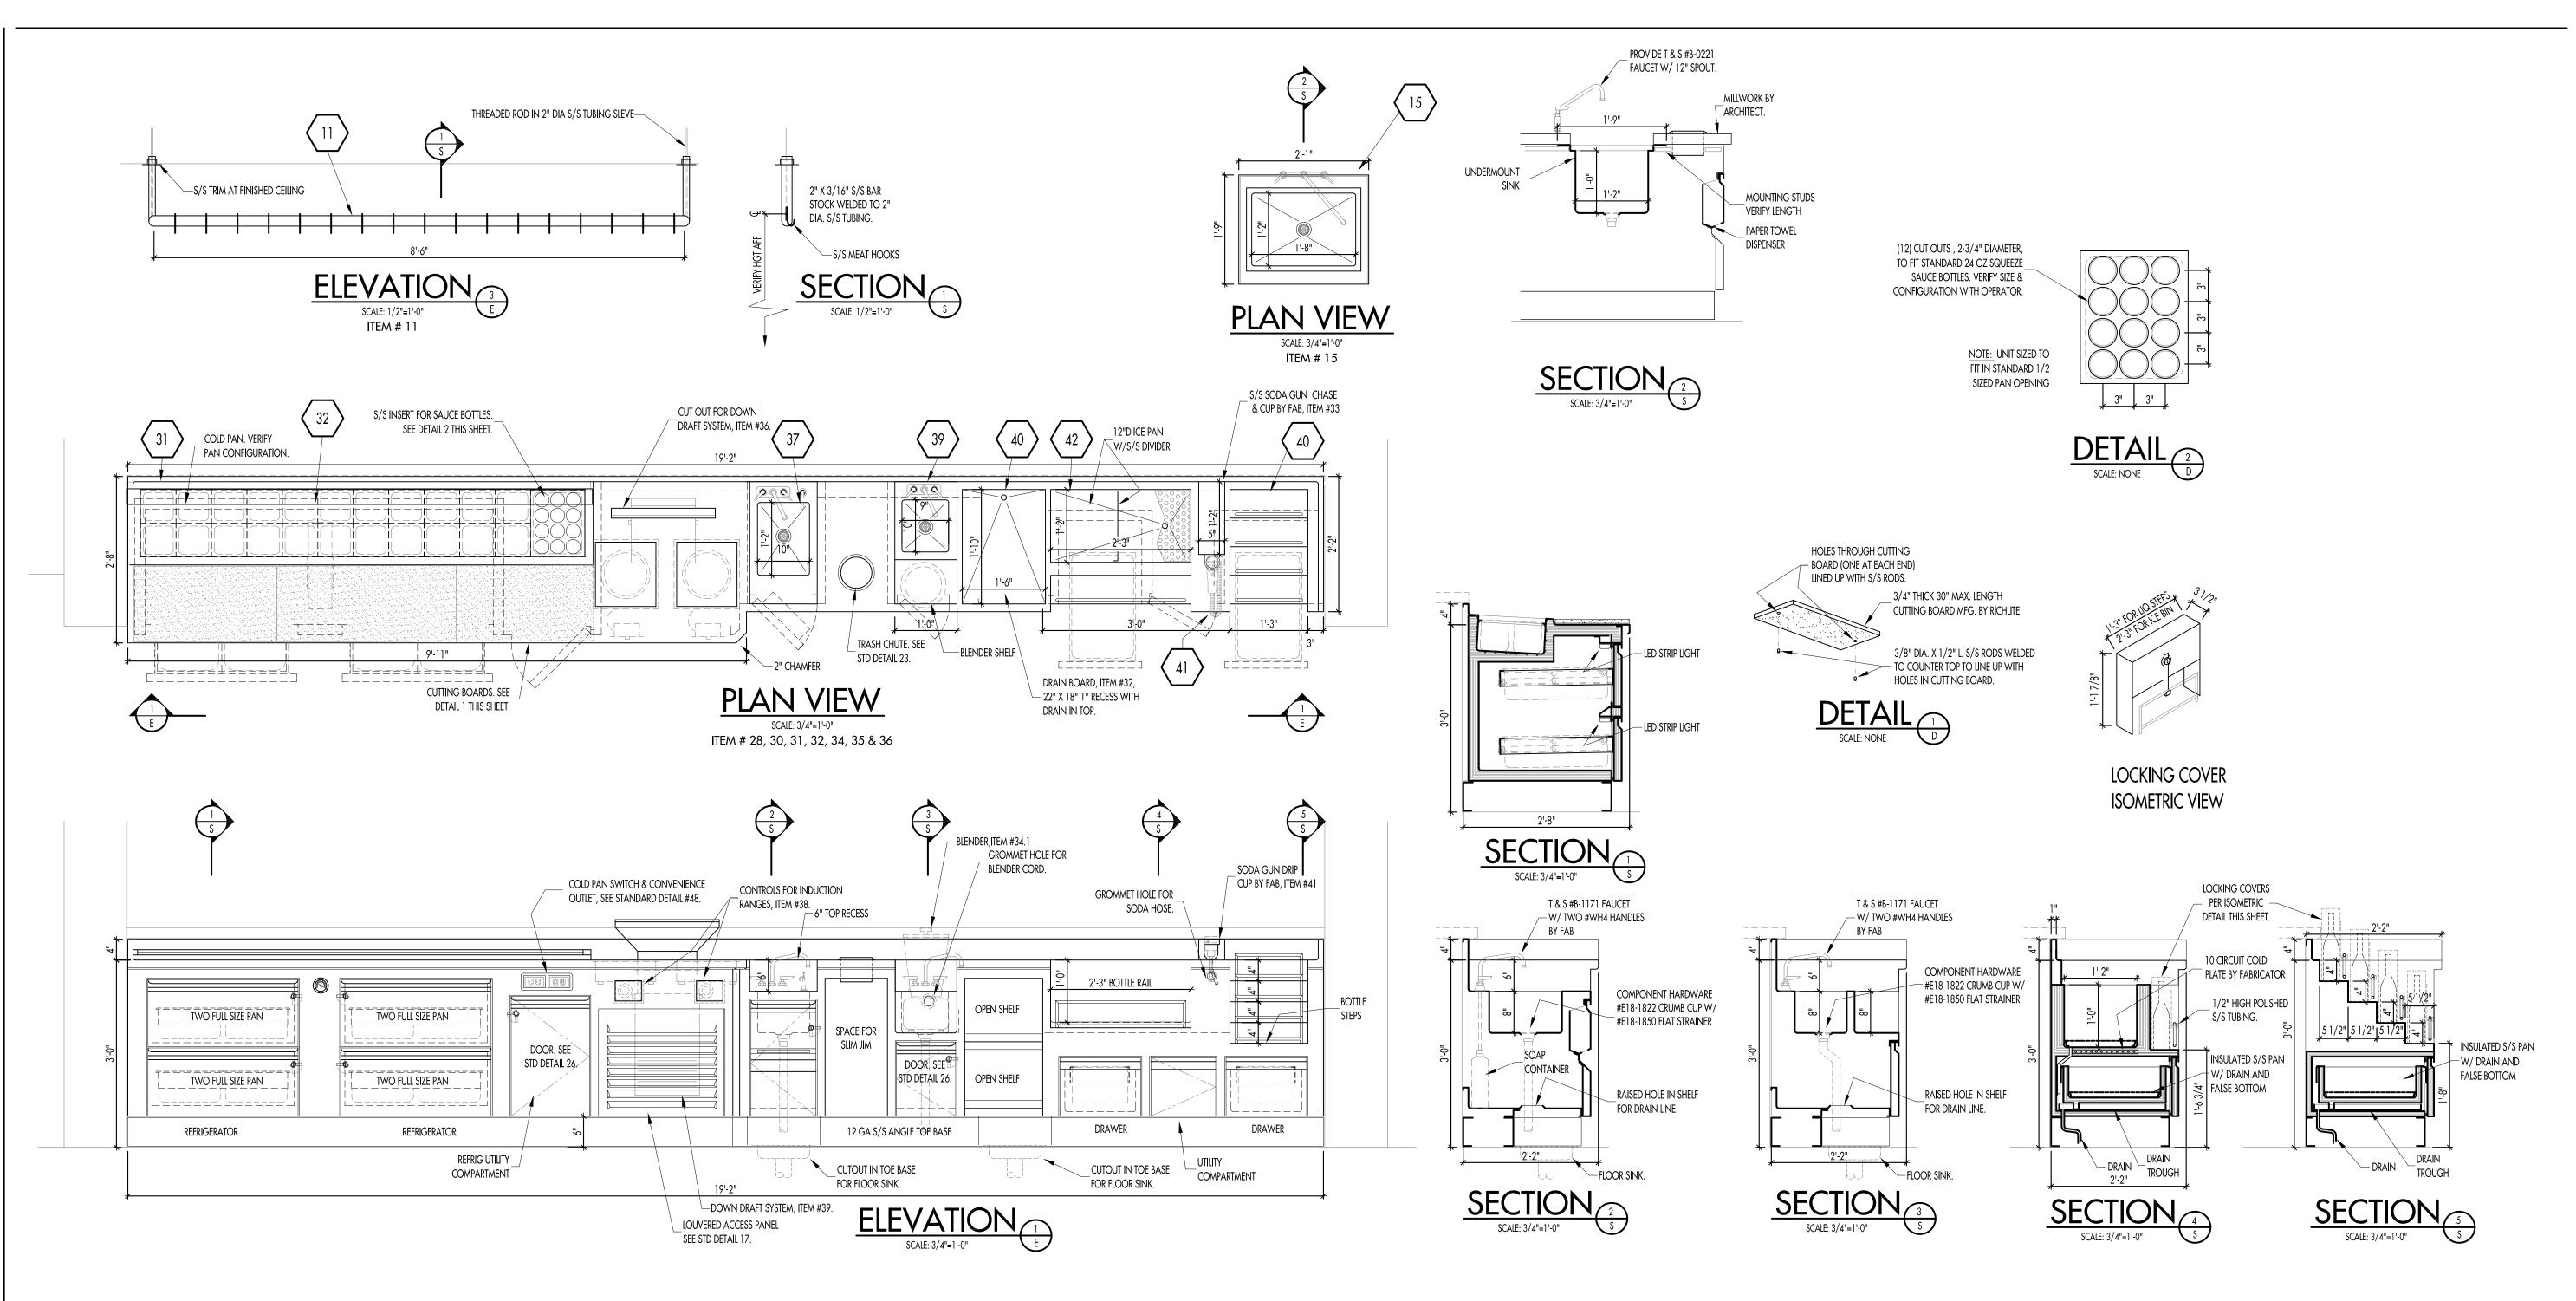

FABRICATION DETAILS

SCALE AS NOTED

FABRICATORS ARE RESPONSIBLE FOR OBTAINING THEIR OWN FIELD DIMENSIONS, LOCATIONS OF ANY REQUIRED FIELD JOINTS, AND FOR VERIFYING ALL CUTOUT AND OPENING DIMENSIONS SHOWN ON THESE DRAWINGS.

<u>COPYRIGHT</u>[©]

UNAUTHORIZED USE OF THE FOODSERVICE DESIGNS, DETAILS, AutoCAD® BLOCKS, AND SPECIFICATIONS CONTAINED IN THESE DOCUMENTS IS STRICTLY PROHIBITED. NSD, INC. MAINTAINS OWNERSHIP OF SAME. THIS PROHIBITION EXTENDS FROM PRINTED MATERIAL TO ANY ELECTRONIC VERSION OF THE SAME. NO USE, OTHER THAN THAT FOR WHICH IT IS INTENDED, IS STRICTLY PROHIBITED WITHOUT WRITTEN PERMISSION FROM NEXT STEP DESIGN, INC. ALL RIGHTS RESERVED.

REFRIGERATION NOTES:

- . ALL FABRICATED COUNTERS WITH REFRIGERATION WILL BE CONSTRUCTED TO CONFORM TO AND BEAR NSF #7 LABEL (OR EQUIVALENT) FOR PERFORMANCE. ALL CABINETS WILL BE CONSTRUCTED TO MEET ALL GENERAL NSF FABRICATION STANDARDS.
- 2. REMOTE REFRIGERATED FABRICATED EQUIPMENT SHALL BE PROVIDED WITH EVAPORATOR COIL, THERMOSTATIC EXPANSION VALVE, THERMOSTATIC CONTROL AND SOLENOID VALVE - FABRICATOR MOUNTED, PRE-WIRED AND PRE-PIPED TO UTILITY COMPARTMENT AS DESIGNATED IN FABRICATION DRAWINGS.
- 3. ALL REMOTE REFRIGERATED BASES TO BE PROVIDED WITH ON-OFF SWITCH LOCATED IN THE UTILITY COMPARTMENT FOR SERVICE OF EVAPORATOR AND CONTROLS.
- 4. REFRIGERATED EQUIPMENT BASES TO BE COMPLETELY PRE-WIRED, INCLUDING LIGHTS AND CONDENSATE HEATERS TO THE UTILITY COMPARTMENT AS DESIGNATED IN THE FABRICATED DRAWINGS.
- 5. ALL SELF-CONTAINED FABRICATED EQUIPMENT WILL CONFORM TO THE ABOVE STANDARDS AND BE PROVIDED WITH CAP AND CORD FOR CONDENSING UNIT DISCONNECT WITH RECEPTACLE AT ELECTRICAL JUNCTION BOX IN UTILITY COMPARTMENT.
- 6. ALL SELF-CONTAINED BASES WILL BE PROVIDED WITH CONDENSATE EVAPORATORS, UNLESS OTHERWISE NOTED IN THE DRAWINGS.
- . ALL REFRIGERATED BASES TO BE PROVIDED WITH 2" DIAL THERMOMETER FACE MOUNTED.

3. MECHANICAL COLD PAN(S) SHALL BE SUPPLIED AND INSTALLED BY FABRICATOR. CONTROL(S) FOR COLD PAN(S) SHALL BE LOCATED IN REFRIGERATION UTILITY COMPARTMENT AS DESIGNATED IN FABRICATION DRAWINGS.

CONSTRUCTION NOTES:


- I. UNLESS OTHERWISE NOTED, METAL GAUGES SHALL BE AS FOLLOWS: A. BASES, INCLUDING EXTERIOR AND INTERIOR WRAPS AND PANELS AND FACES OF DOORS, DRAWERS, AND ACCESS PANELS TO BE 18GA S/S
- B. TOPS, SINK BOWLS, AND SPLASHES TO BE 14GA S/S C. WALL AND TABLE MOUNTED SHELVES TO BE 16GA S/S. WALL SHELVES TO
- BE SUPPORTED USING 14GA S/S BRACKETS. TABLE MOUNTED SHELVES TO BE SUPPORTED USING 1 5/8" ROUND S/S TUBING AND 14GA S/S GUSSETS. D. WALL CABINET WRAPS AND DOOR FACES TO BE 18GA S/S. INTERIOR
- SHELVES TO BE 16GA S/S. E. INTERIOR REFRIGERATOR, FREEZER, & HEATED CABINET WRAPS TO BE 20GA S/S.
- F. OPEN CABINET BASE & WORK TABLE UNDERSHELVES TO BE 16GA S/S.
- 2. UNLESS OTHERWISE NOTED, ALL EDGES SHALL BE AS FOLLOWS: A. COUNTER TOPS: FLAT EDGE - DETAIL 2
- B. CHEF COUNTER DOUBLE PASS-OVER SHELVES: LONG FLAT EDGE DETAIL 6
- C. UNDERSHELVES: FLAT EDGE DETAIL 2 D. WALL SHELVES: FLAT EDGE - DETAIL 2
- B. FULL HEIGHT LEGS CONSTRUCTED FROM 1 5/8" DIA. S/S TUBING W/ ADJ. S/S HEX SHAPED OR FLANGED FEET AS SHOWN. LEGS SECURED TO TABLE USING S/S LEG SOCKETS W/ LOCKING SET SCREWS. SOCKETS WELDED TO UNDERSIDE OF TABLE.
- 4. CROSSBRACING TO BE 1 1/4" DIA. S/S TUBING.
- 5. 6" LEGS TO BE COMPONENT HARDWARE #A77-5048-C W/ FLANGE FOR WELDING
- 6. ALL EXPOSED CHANNEL FRAMING TO BE 14GA S/S. USE 14GA GALV. OTHERWISE.
- 7. ALL CUTTING BOARDS TO BE 3/4" THICK AND MANUFACTURED BY RICHLITE.
- 8. PROVIDE SOUND DEADENING MATERIAL ON UNDERSIDE OF ALL TOPS. PROVIDE (1) ORANGE FACE S.R. SINGLE RECEPTACLE FOR PRINTER AND (1) EMPTY

J.B. FOR POS DATA CABLE. USE COMPONENT HARDWARE #R58-1010. RUN

- (CONCEALED) CONDUIT W/ PULL STRING FROM EACH PRINTER DATA BOX TO SUB PANEL COMPARTMENT.
- 10. PROVIDE DRAWERS AND DOORS WITH LOCKS AND PROVIDE SINGLE KEY TO FIT ALL. SEE DETAILS 26, 27, 28, & 29.
- FABRICATOR TO PROVIDE ELECTRICAL SUB-PANEL WHERE DESIGNATED, PROVIDE AND INSTALL ALL ELECTRICAL BOXES AND OUTLETS, AND PRE-WIRE ENTIRE COUNTER TO ELECTRICAL SUB-PANEL. FABRICATOR TO MAKE COUNTER READY FOR FINAL SINGLE POINT CONNECTION. FABRICATOR TO PROVIDE U.L., TESTING.

SUBMITTAL	DATE
~	
~	
~	
~	
~	
~	



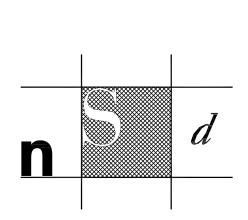

Next Step Design FOODSERVICE CONSULTANTS

913 West Street, Suite A Annapolis, MD 21401

Ph: (410) 263-1200

Fx: (410) 280-1340 www.nextstepdesign.com

DATE: SCALE: AS NOTED

PROJECT #: DRAWN: D-91*75* JRLS

> **FOODSERVICE** FABRICATION DETAILS